
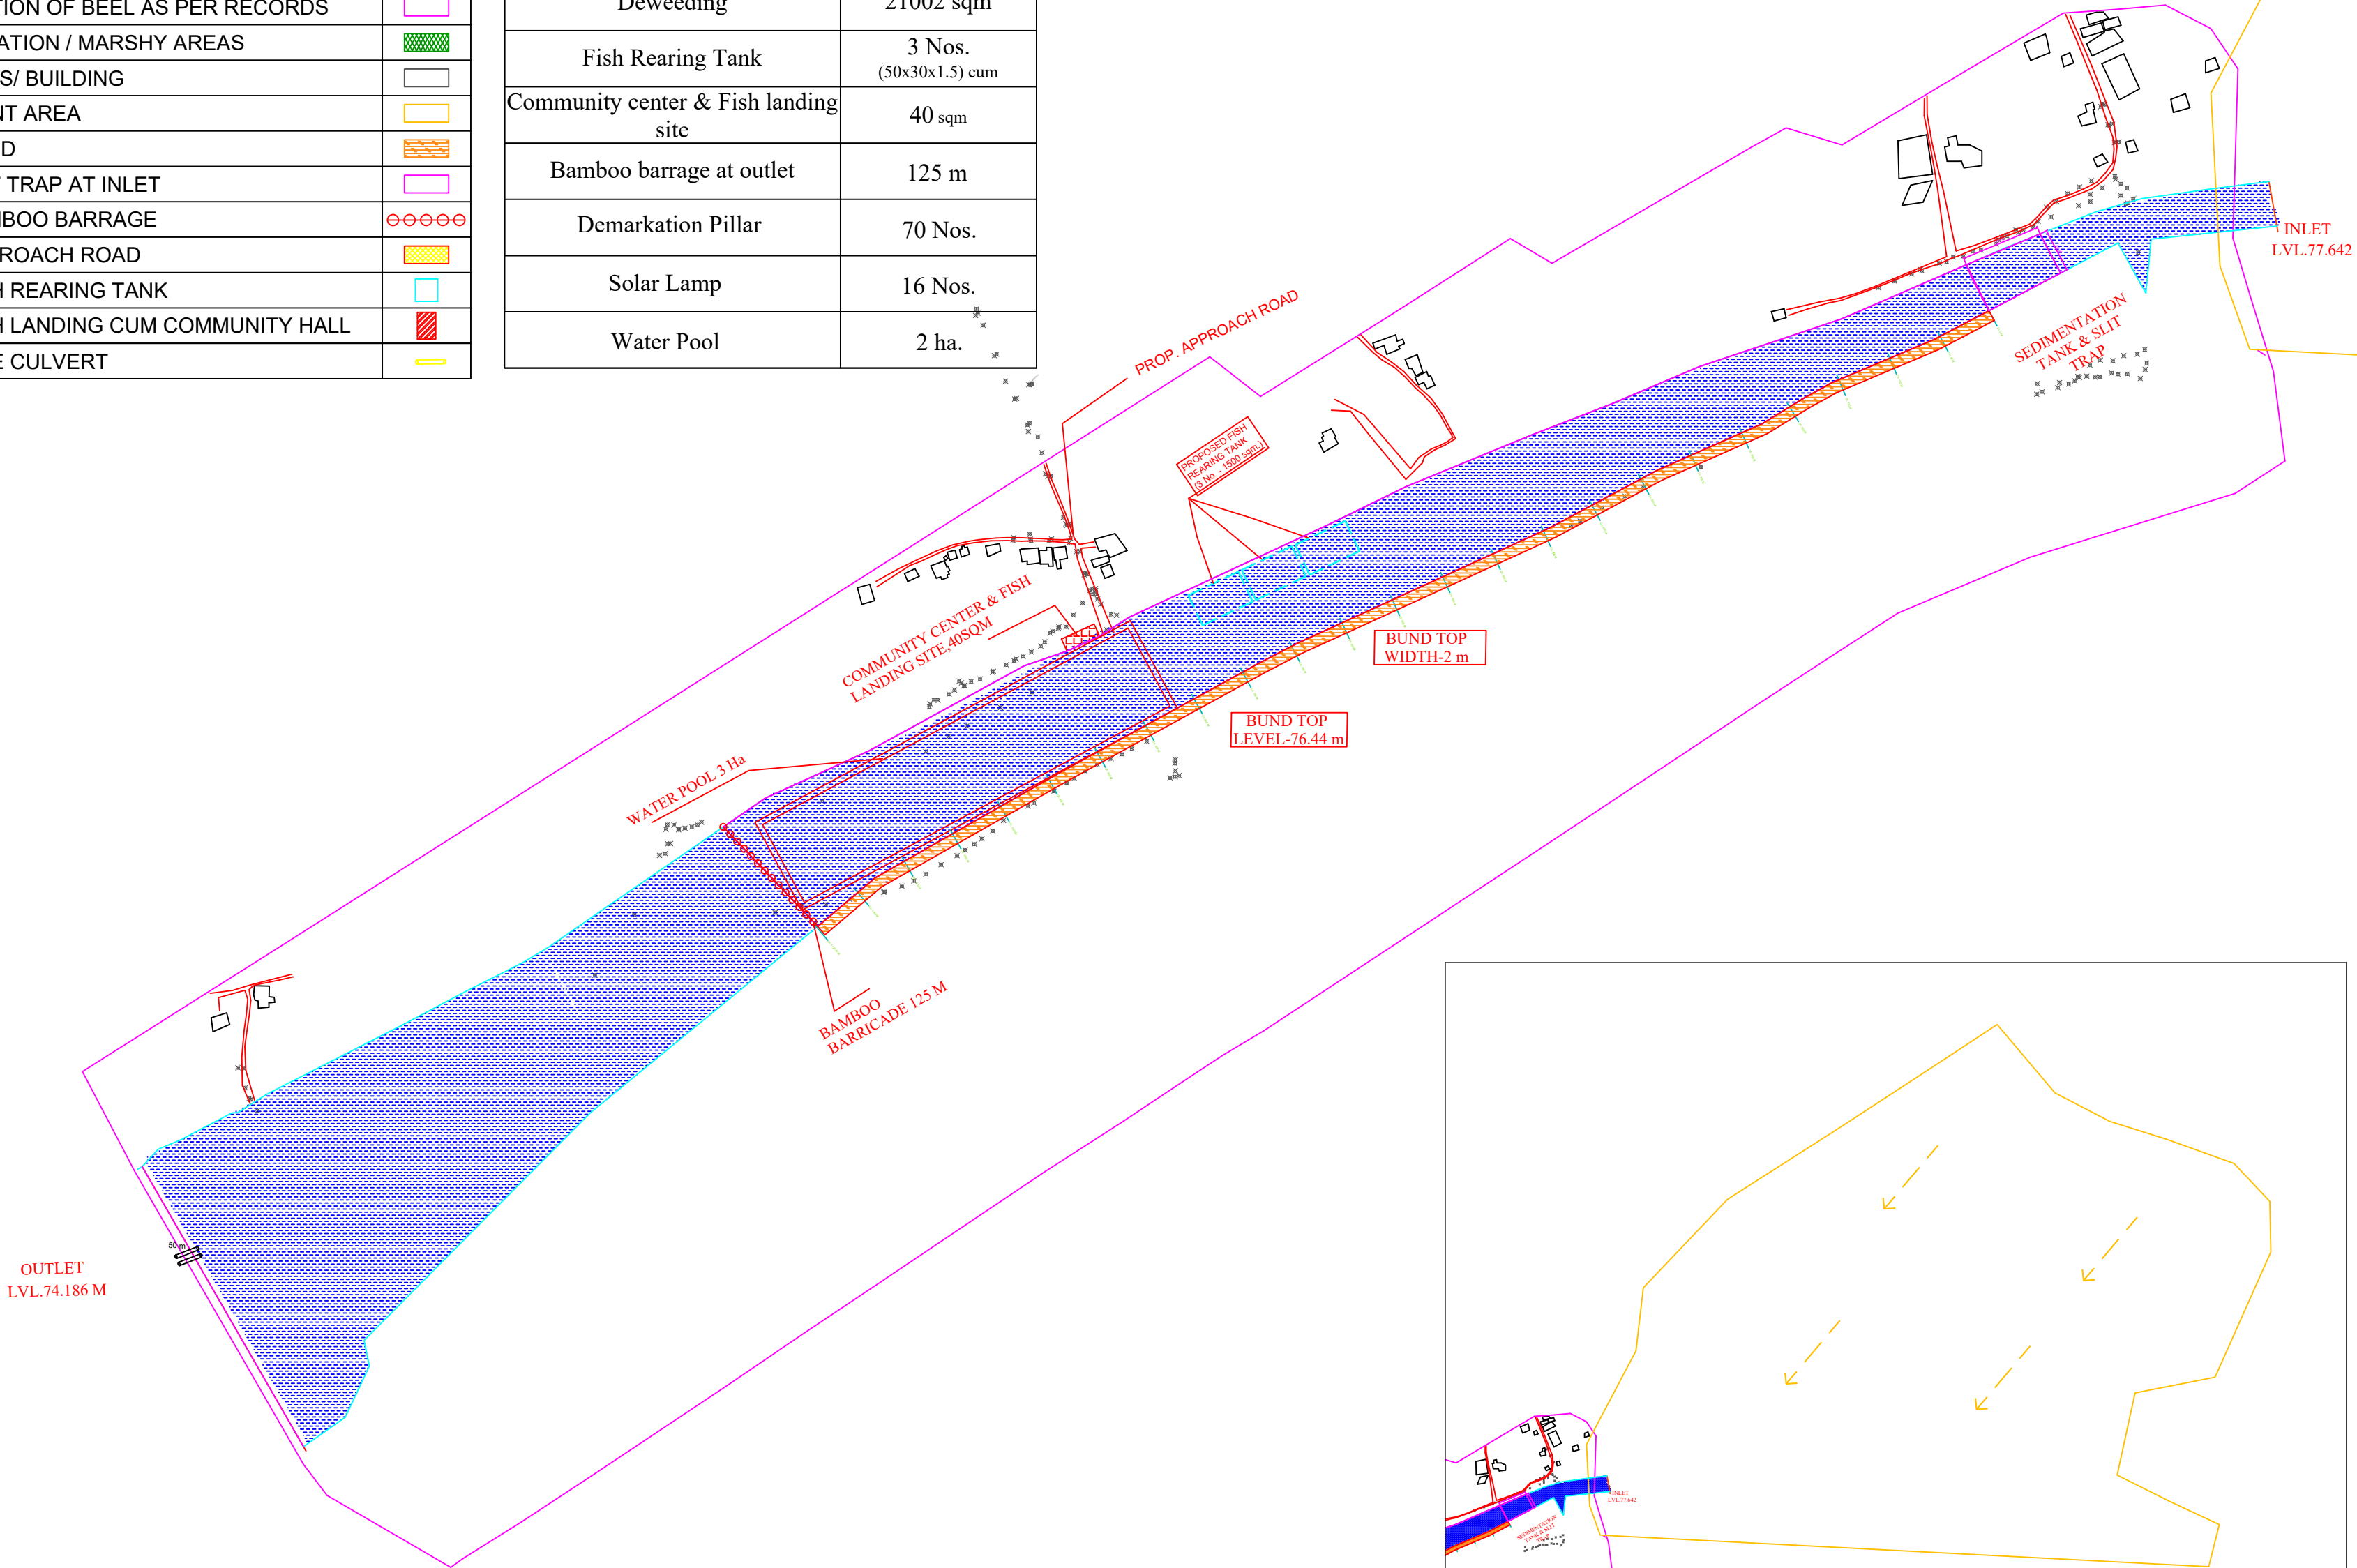


MASTER PLAN LAYOUT OF GOMIRI BEEL

LEGENDS :

BOUNDARY	
EX. ROAD	
EX. RAILWAY	
BENCH MARK	
EX. CULVERT	
EX. BRIDGE	
EX. RIVER/ STREAM/ POND	
BEEL	
DEMARCATON OF BEEL AS PER RECORDS	
EX. VEGETATION / MARSHY AREAS	
EX. HOUSES/ BUILDING	
CATCHMENT AREA	
PROP. BUND	
PROP. SILT TRAP AT INLET	
PROP. BAMBOO BARRAGE	
PROP. APPROACH ROAD	
PROP. FISH REARING TANK	
PROP. FISH LANDING CUM COMMUNITY HALL	
PROP. PIPE CULVERT	


PROPOSED WORKS	
DESCRIPTION OF WORK	SPECIFICATION
Earthen Bund	1120 m
Silt Trap	46 m
Desilting	30000 cum
Deweeding	21002 sqm
Fish Rearing Tank	3 Nos. (50x30x1.5) cum
Community center & Fish landing site	40 sqm
Bamboo barrage at outlet	125 m
Demarkation Pillar	70 Nos.
Solar Lamp	16 Nos.
Water Pool	2 ha.

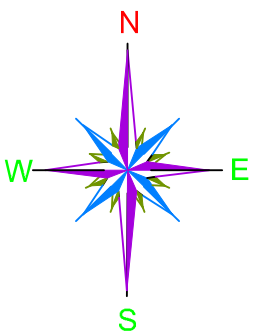


PACKAGE NO.:		02	
NAME OF THE BEEL:			
GORIMI BEEL			
DEVELOPMENT BLOCK:			
CHAIDAU			
REVENUE VILLAGE:			
MIRI PATHAR GAON			
DISTRICT:			
BISWANATH			
AREA (Ha):			
10 Ha			
PROJECT TITLE:			
Sustainable Wetlands and Integrated Fisheries Transformation (SWIFT) Project			
CLIENT :			
<div></div>			
CONSULTANT :			
<div></div>			
DWG TITLE :			
MASTERV PLAN LAYOUT OF GORIMI BEEL			
DATE :			
CHECKED BY:	SUBMITTED TO:	RECOMMENDED BY:	APPROVED BY:
DATE :	DATE :	DATE :	DATE :
TEAM LEAD	A.E.	E.E.	S.E.

CATCHMENT AREA DRAWING

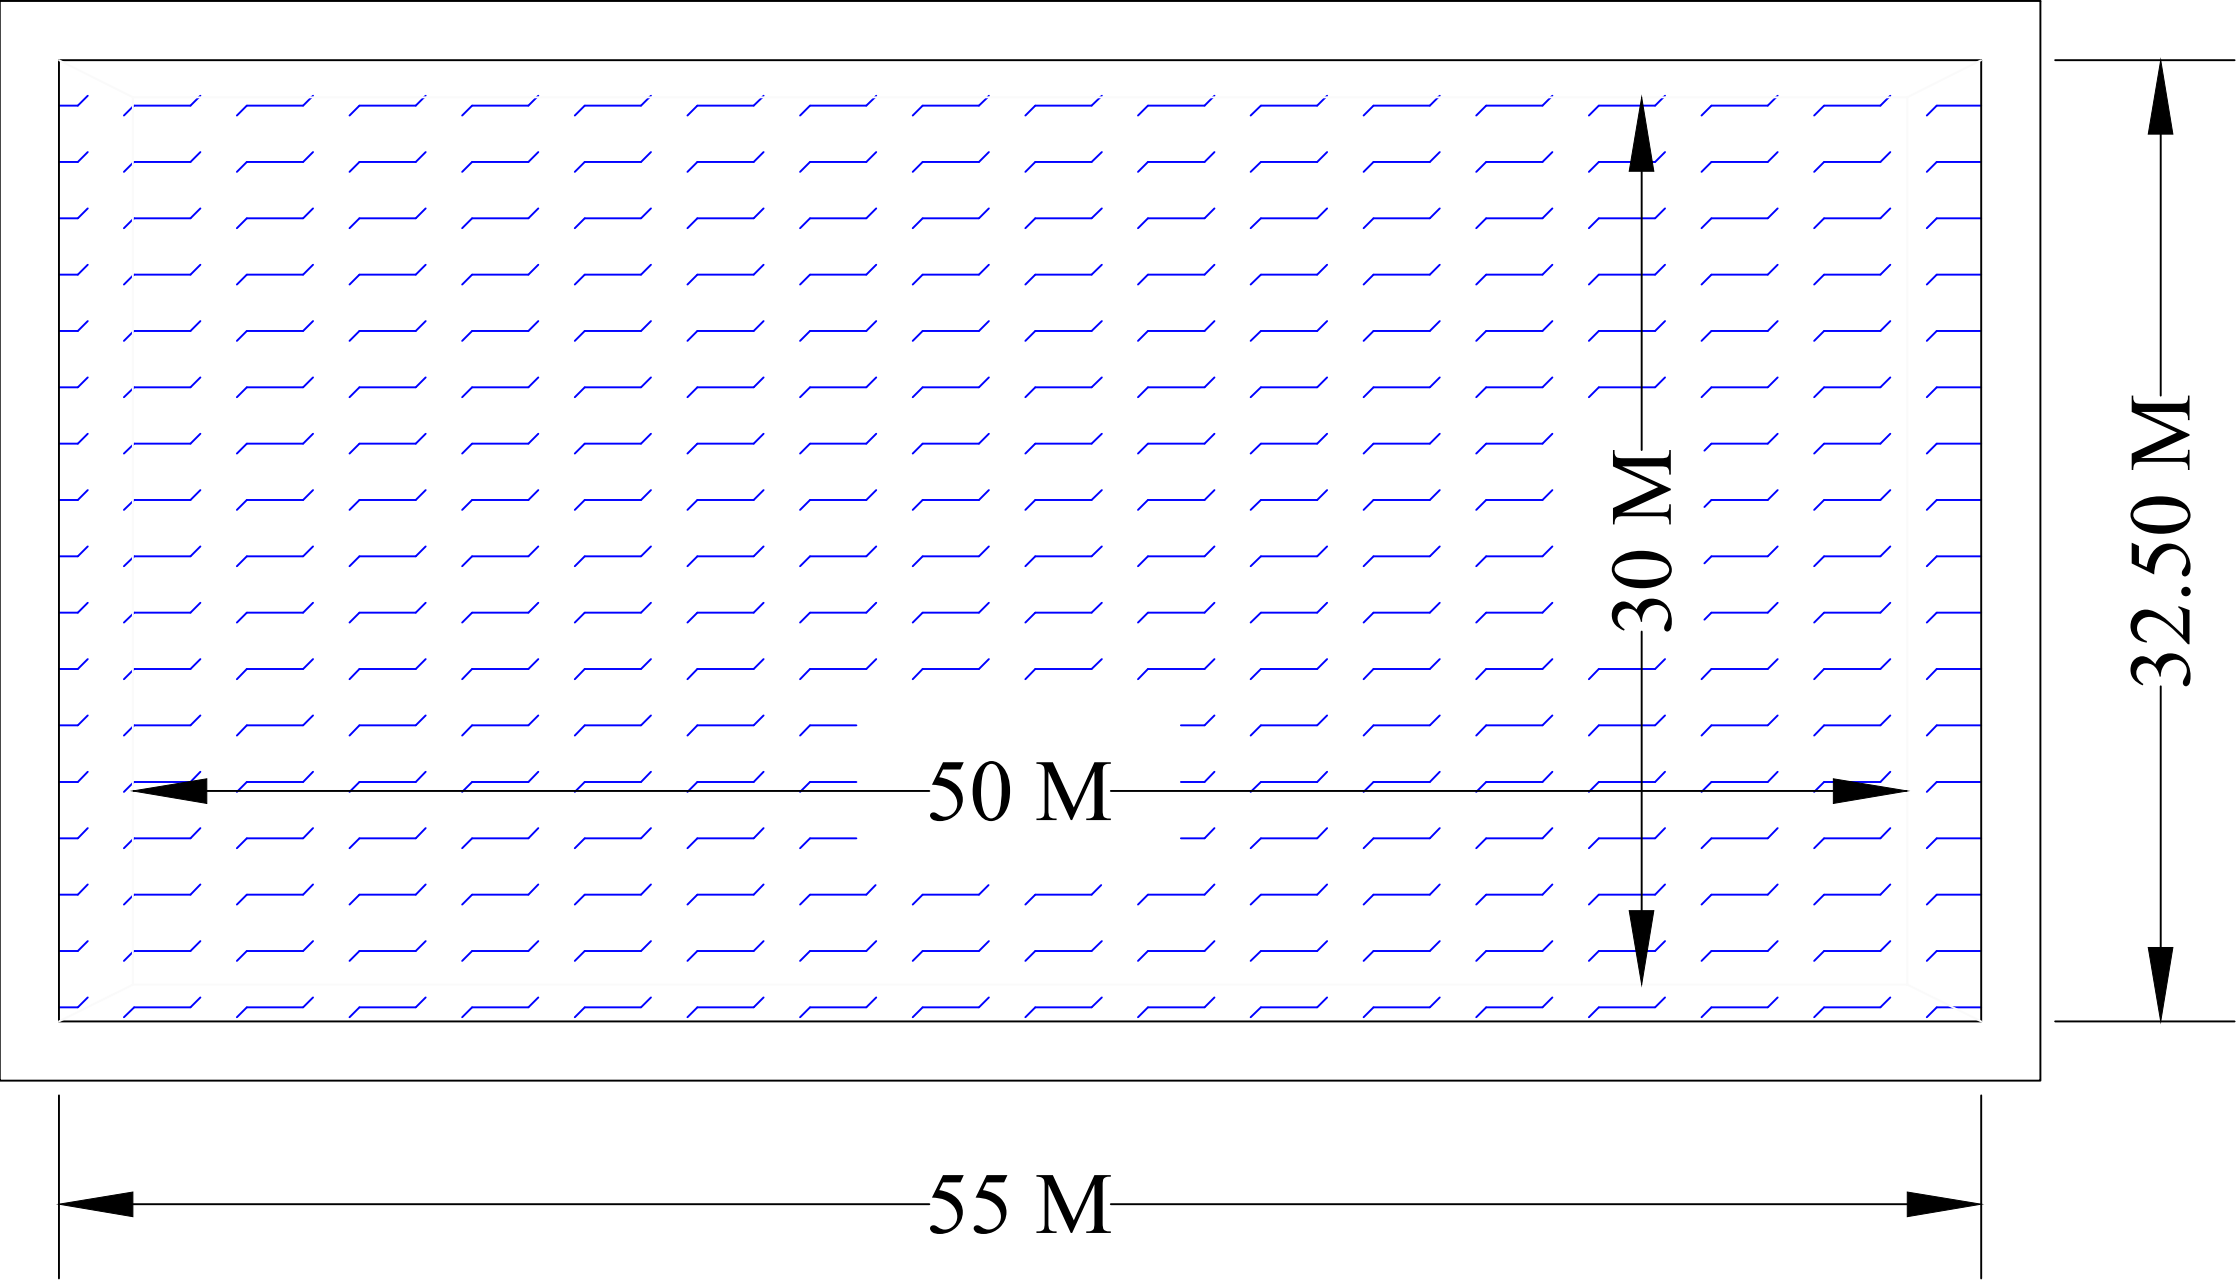

TYPICAL PLAN & SECTION OF REARING TANK


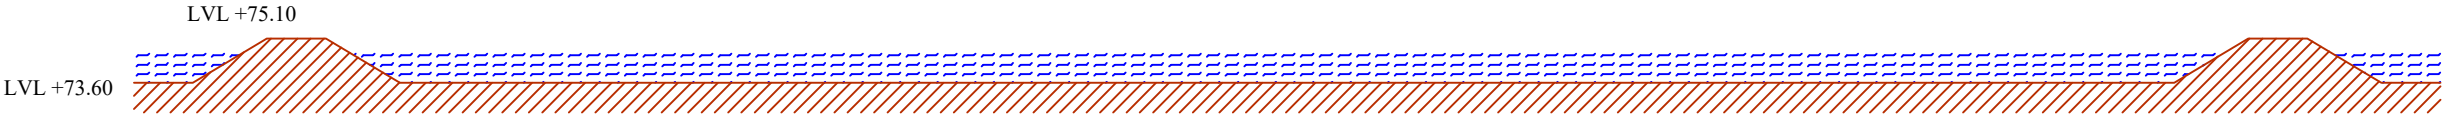


PLAN



SECTION¹⁰⁰

SCALE: NOT TO SCALE			
PROJECT TITLE: Sustainable Wetlands and Integrated Fisheries Transformation (SWIFT) Project			
CLIENT :  ARIAS Society GOVERNMENT OF ASSAM Assam Rural Infrastructure and Agricultural Services Society			
CONSULTANT :  Shubh Consultants & Technocrats LLP			
DWG TITLE : TYPICAL PLAN & SECTION OF REARING TANK OF 1500 SQM			
DATE :			
CHECKED BY:	SUBMITTED TO:	RECOMMENDED BY:	APPROVED BY:
DATE :	DATE :	DATE :	DATE :
TEAM LEAD	A.E.	E.E.	S.E.

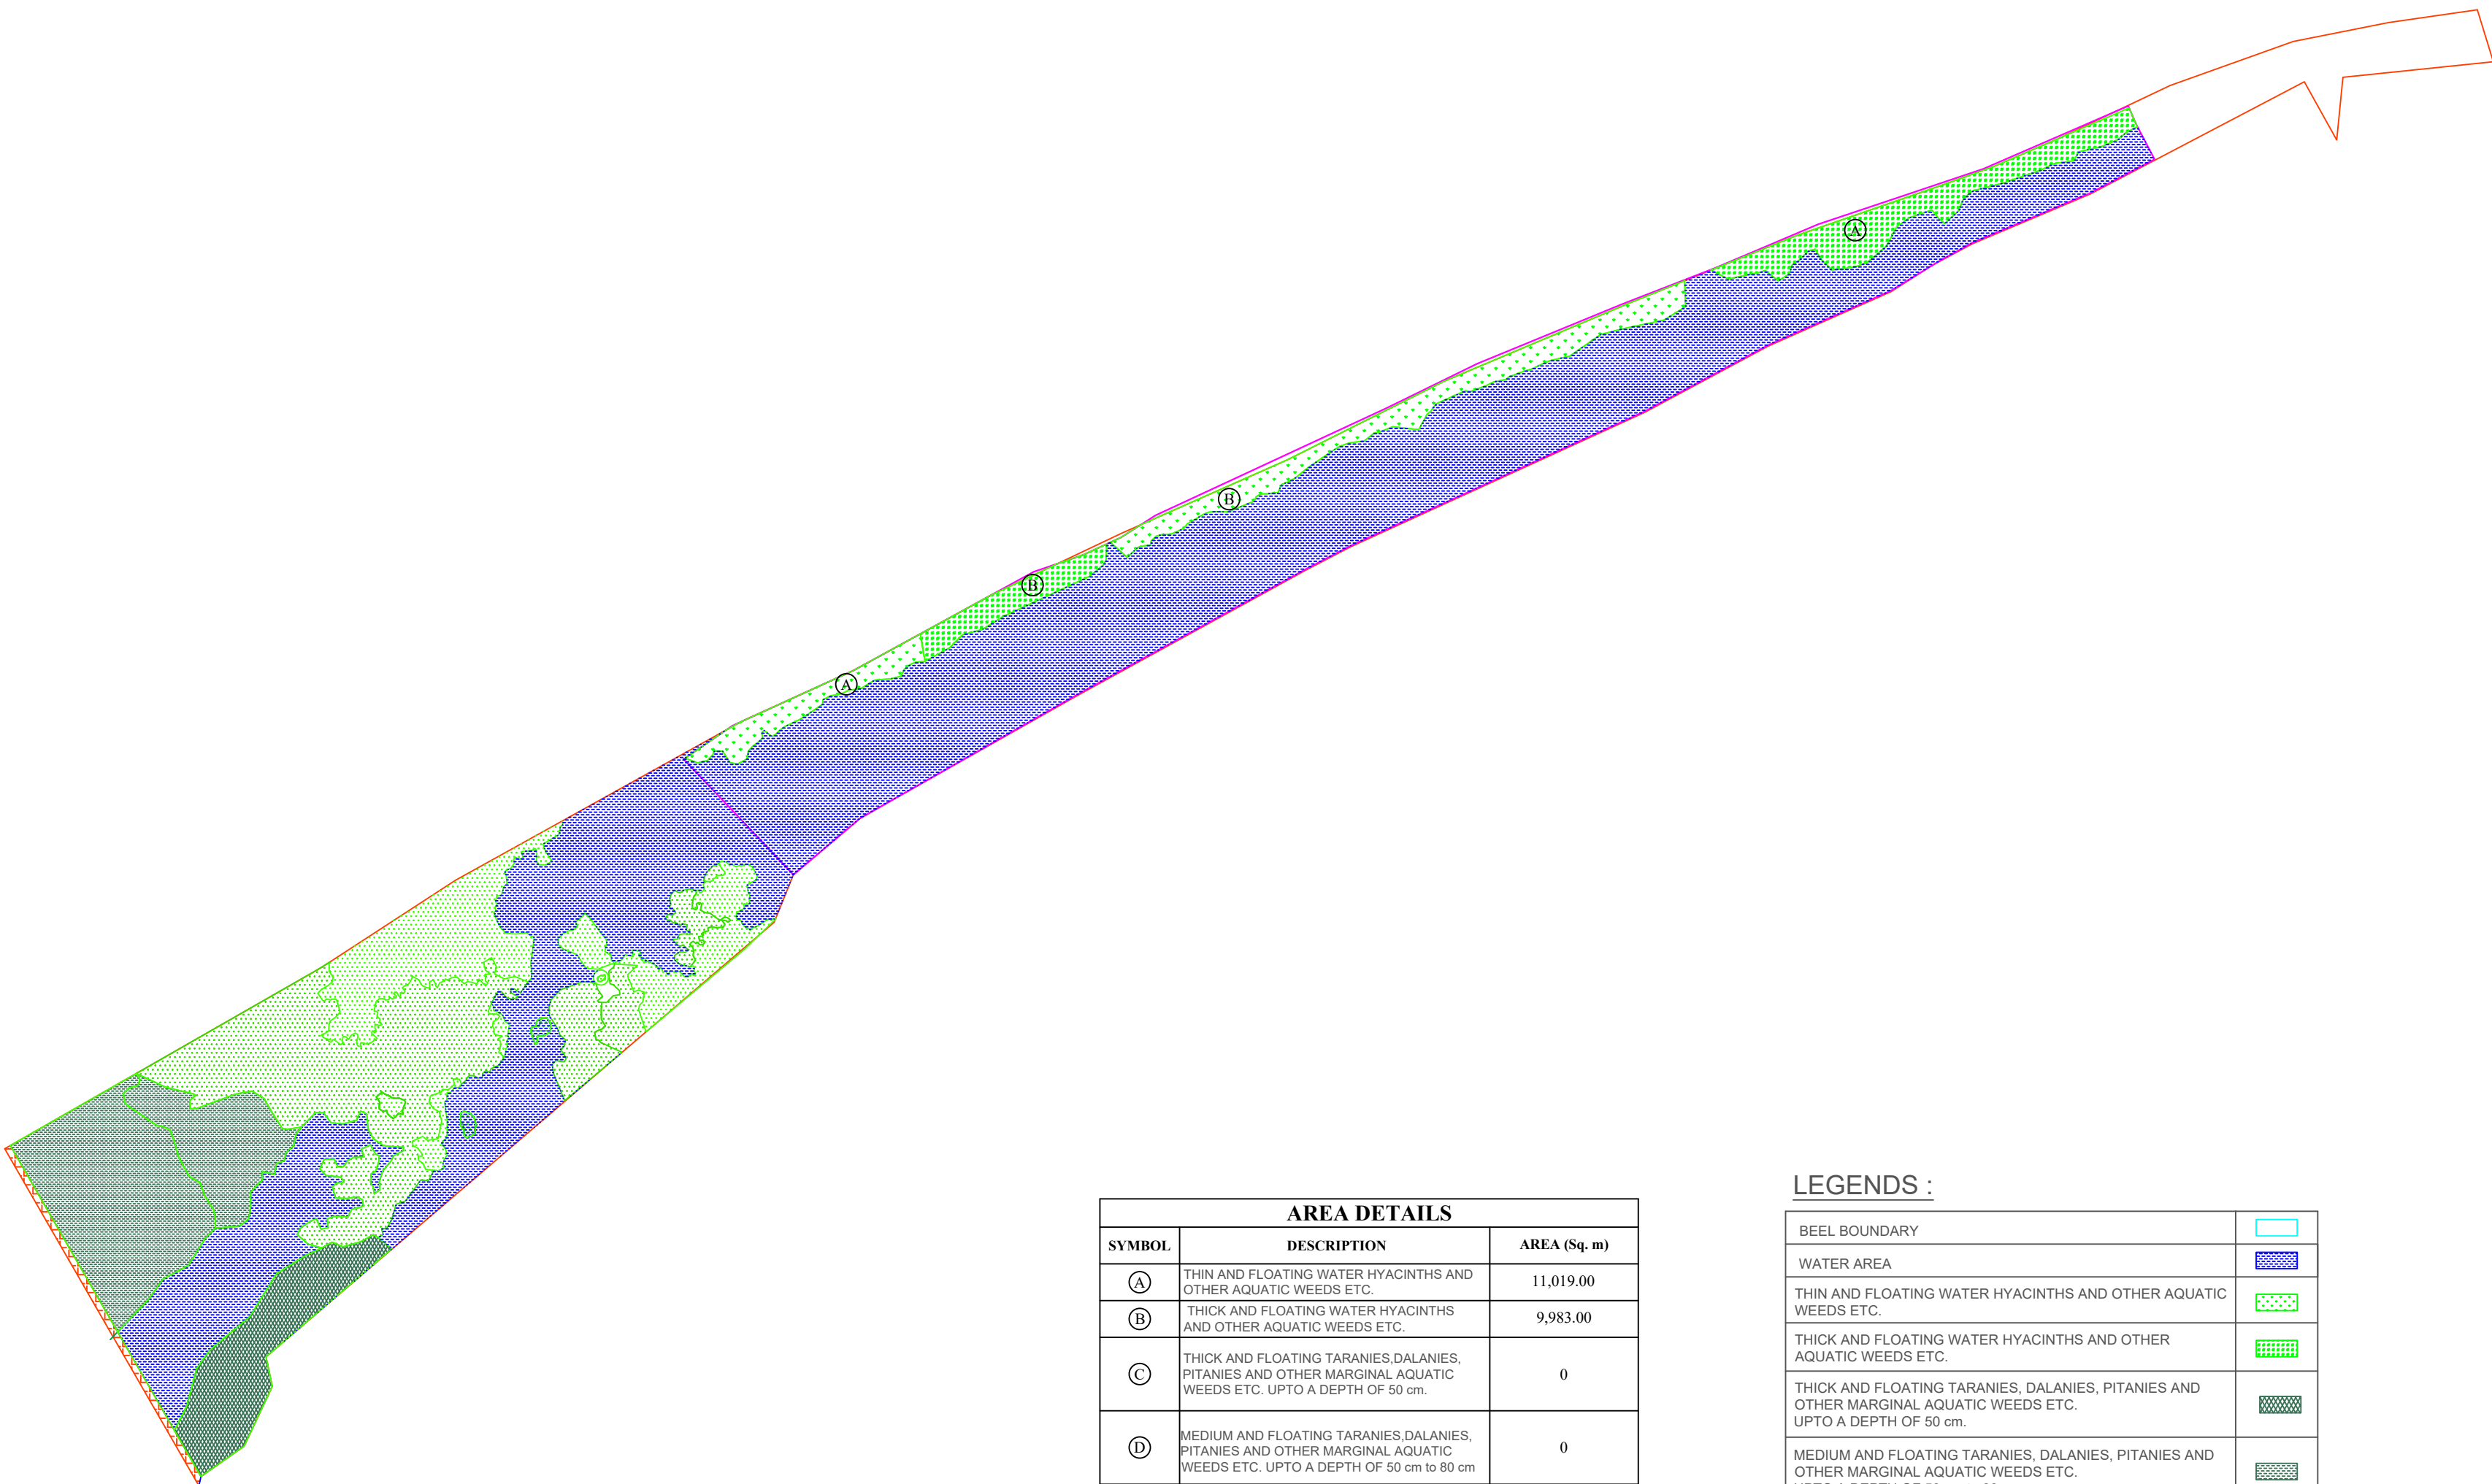
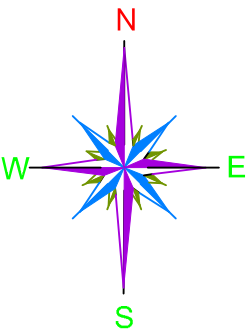


AREA DETAILS		
SYMBOL	DESCRIPTION	AREA (Sq. m)
Ⓐ	THIN AND FLOATING WATER HYACINTHS AND OTHER AQUATIC WEEDS ETC.	11,019.00
Ⓑ	THICK AND FLOATING WATER HYACINTHS AND OTHER AQUATIC WEEDS ETC.	9,983.00
Ⓒ	THICK AND FLOATING TARANIES,DALANIES, PITANIES AND OTHER MARGINAL AQUATIC WEEDS ETC. UPTO A DEPTH OF 50 cm.	0
Ⓓ	MEDIUM AND FLOATING TARANIES,DALANIES, PITANIES AND OTHER MARGINAL AQUATIC WEEDS ETC. UPTO A DEPTH OF 50 cm to 80 cm	0
Ⓔ	HEAVY AND FLOATING TARANIES,DALANIES, PITANIES AND OTHER MARGINAL AQUATIC WEEDS ETC. UPTO A DEPTH OF 80 cm to 120 cm	0

LEGENDS :

BEEL BOUNDARY	
WATER AREA	
THIN AND FLOATING WATER HYACINTHS AND OTHER AQUATIC WEEDS ETC.	
THICK AND FLOATING WATER HYACINTHS AND OTHER AQUATIC WEEDS ETC.	
THICK AND FLOATING TARANIES, DALANIES, PITANIES AND OTHER MARGINAL AQUATIC WEEDS ETC. UPTO A DEPTH OF 50 cm.	
MEDIUM AND FLOATING TARANIES, DALANIES, PITANIES AND OTHER MARGINAL AQUATIC WEEDS ETC. UPTO A DEPTH OF 50 cm to 80 cm.	
HEAVY AND FLOATING TARANIES, DALANIES, PITANIES AND OTHER MARGINAL AQUATIC WEEDS ETC. UPTO A DEPTH OF 80 cm to 120 cm.	

PACKAGE NO.:			
02			
NAME OF THE BEEL:			
GORIMI BEEL			
DEVELOPMENT BLOCK:			
CHAIDAU			
REVENUE VILLAGE:			
MIRI PATHAR GAON			
DISTRICT:			
BISWANATH			
AREA (Ha):			
10 Ha			
PROJECT TITLE:			
Sustainable Wetlands and Integrated Fisheries Transformation (SWIFT) Project			
CLIENT :			
CONSULTANT :			
DWG TITLE :			
VEGETAION LAYOUT OF GORIMI BEEL			
DATE :			
CHECKED BY:	SUBMITTED TO:	RECOMMENDED BY:	APPROVED BY:
DATE :	DATE :	DATE :	DATE :
TEAM LEAD	A.E.	E.E.	S.E.

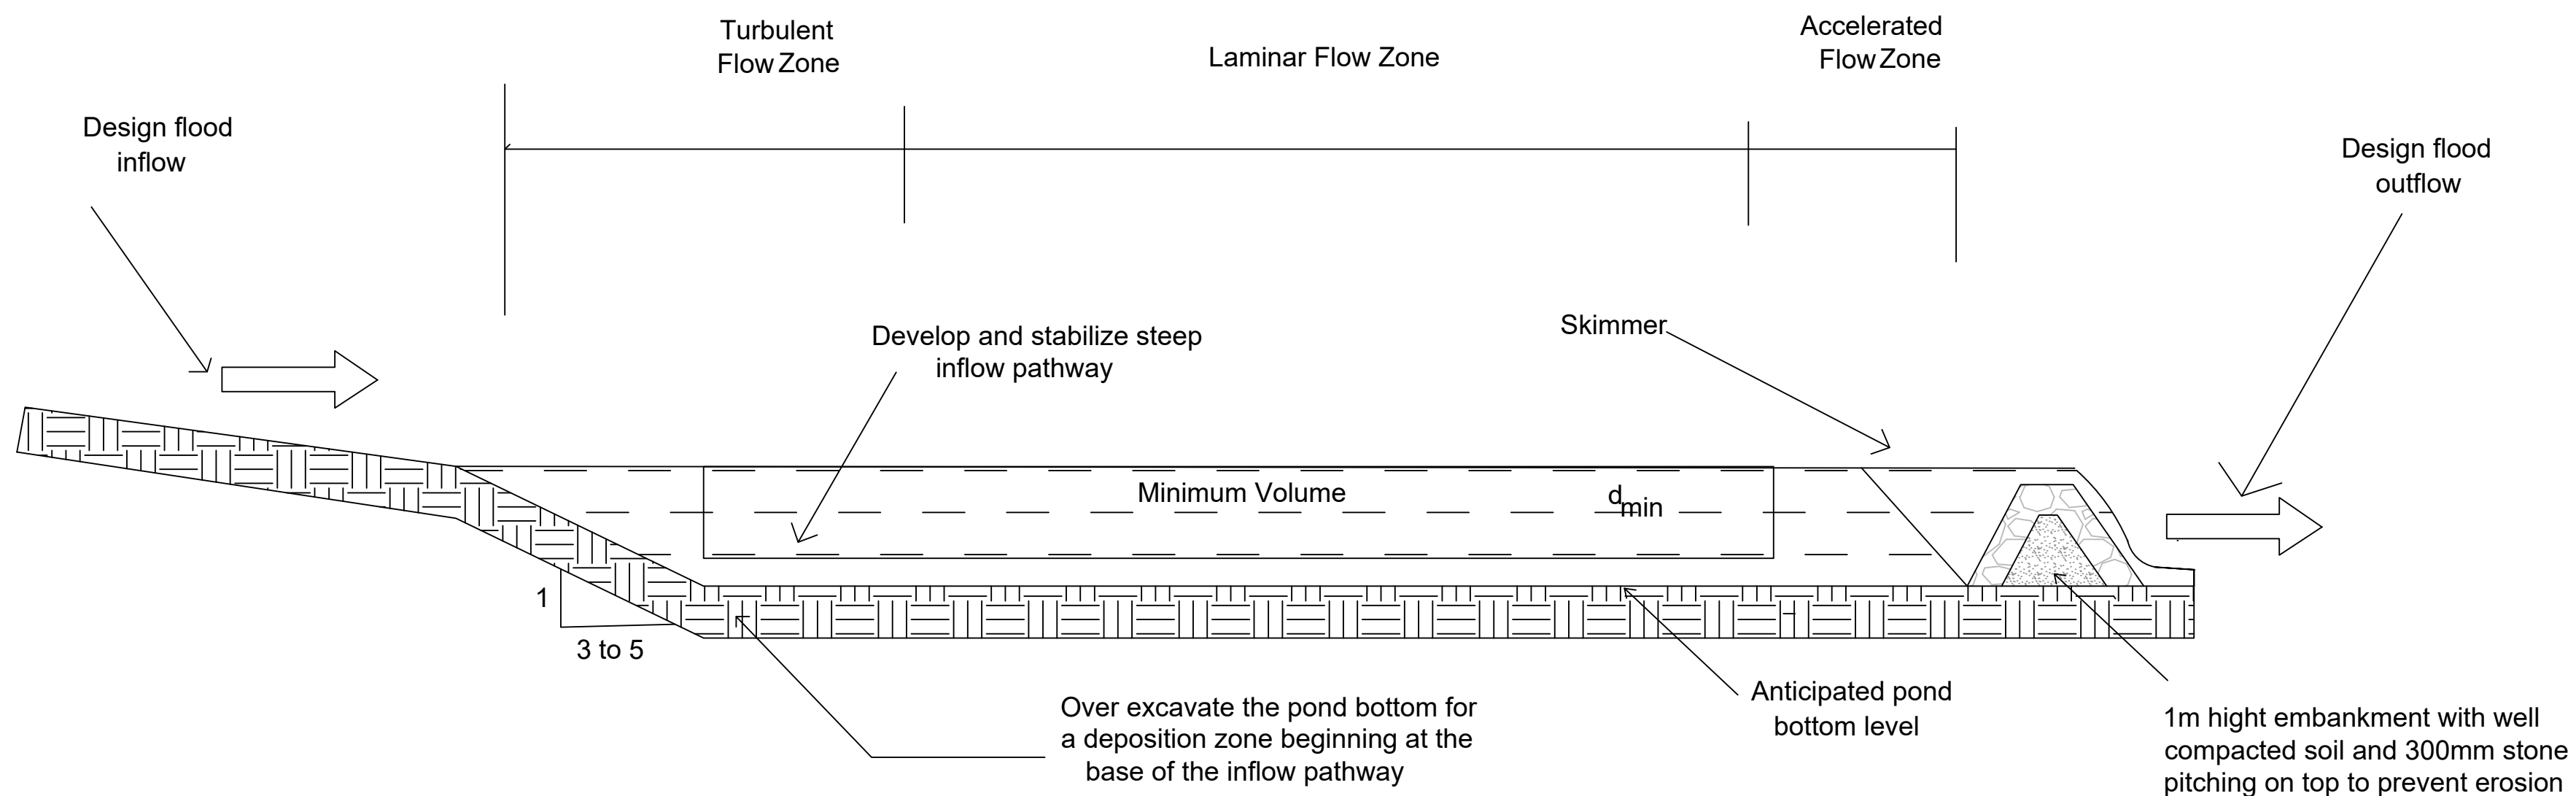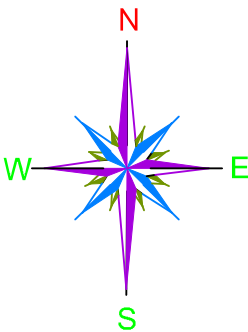

SCALE: NOT TO SCALE

<p>PROJECT TITLE:</p> <p>Sustainable Wetlands and Integrated Fisheries Transformation (SWIFT) Project</p>
--

CLIENT :



CONSULTANT :




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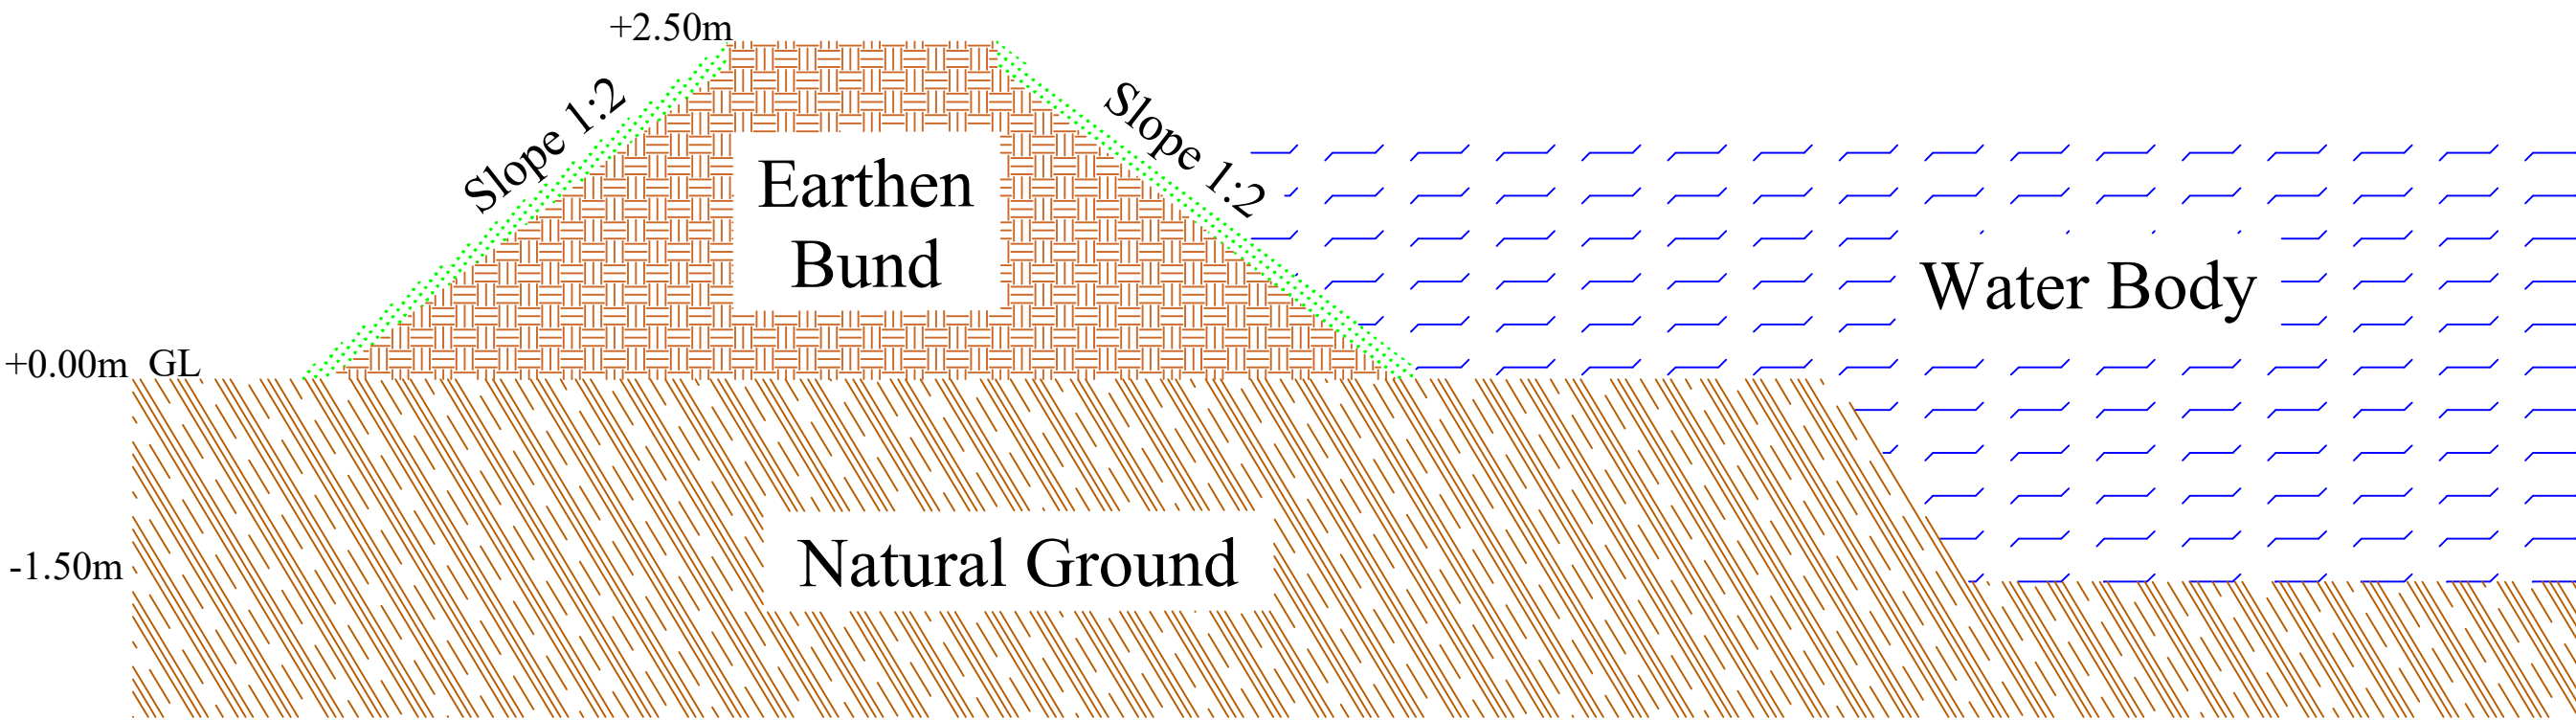
PLAN & CROSS-SECTION OF SILT TRAP FOR GOMIRI BEEL

DATE :

CHECKED BY:	SUBMITTED TO:	RECOMMENDED BY:	APPROVED BY:
DATE :	DATE :	DATE :	DATE :
TEAM LEAD	A.E.	E.E.	S.E.

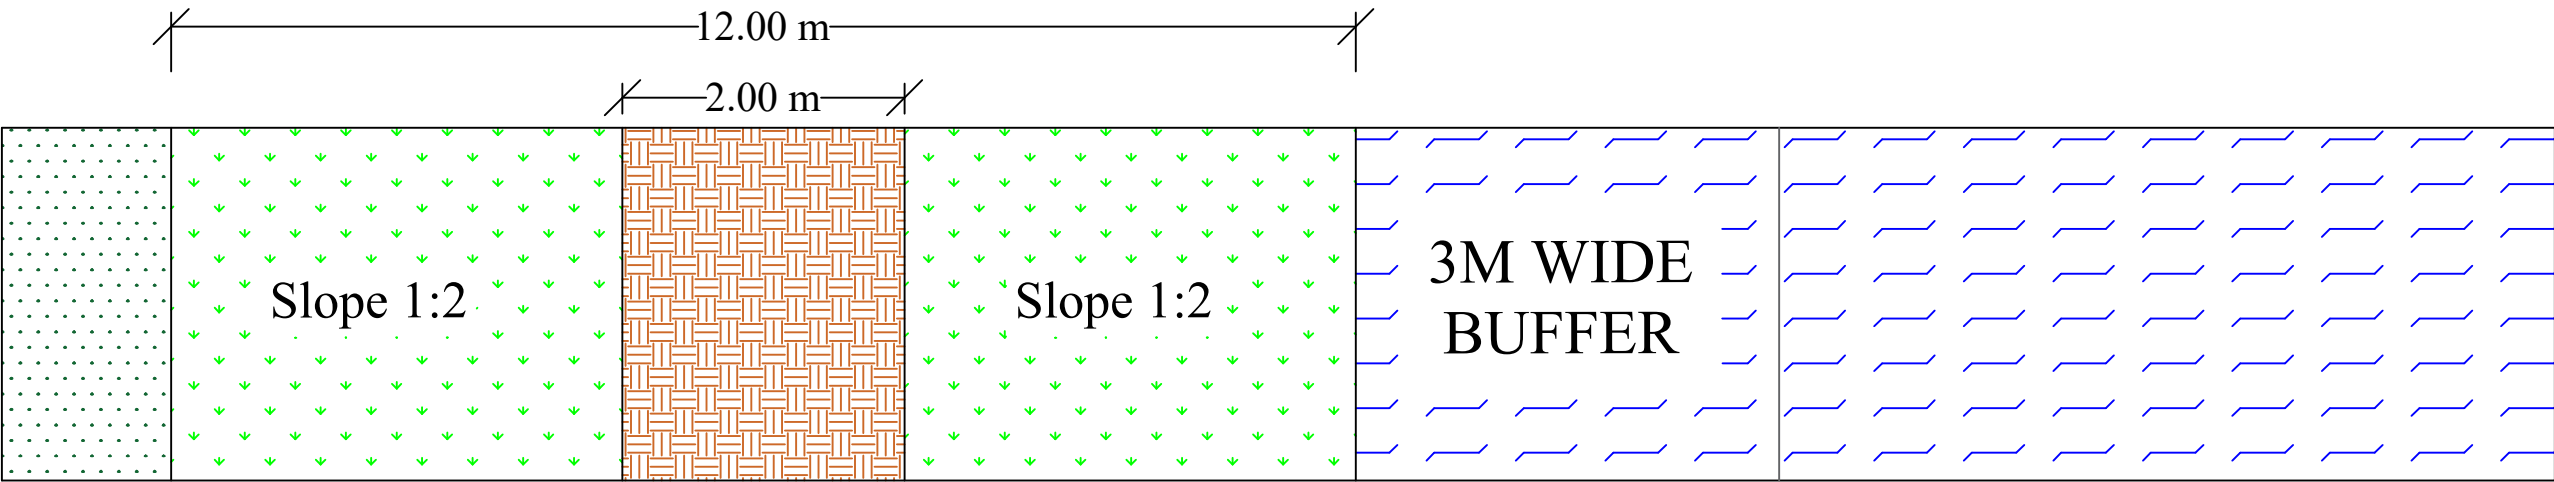

PLAN



CROSS - SECTION

SCALE: NOT TO SCALE




PROJECT TITLE:
Sustainable Wetlands and Integrated Fisheries Transformation (SWIFT) Project

CLIENT :
 **ARIAS Society**
GOVERNMENT OF ASSAM
Assam Rural Infrastructure and Agricultural Services Society

CONSULTANT :
 **Shubh**
Consultants & Technocrats LLP

DWG TITLE :
TYPICAL PLAN & CROSS-SECTION OF EARTHEN BUND

DATE :			
CHECKED BY:	SUBMITTED TO:	RECOMMENDED BY:	APPROVED BY:
DATE :	DATE :	DATE :	DATE :
TEAM LEAD	A.E.	E.E.	S.E.

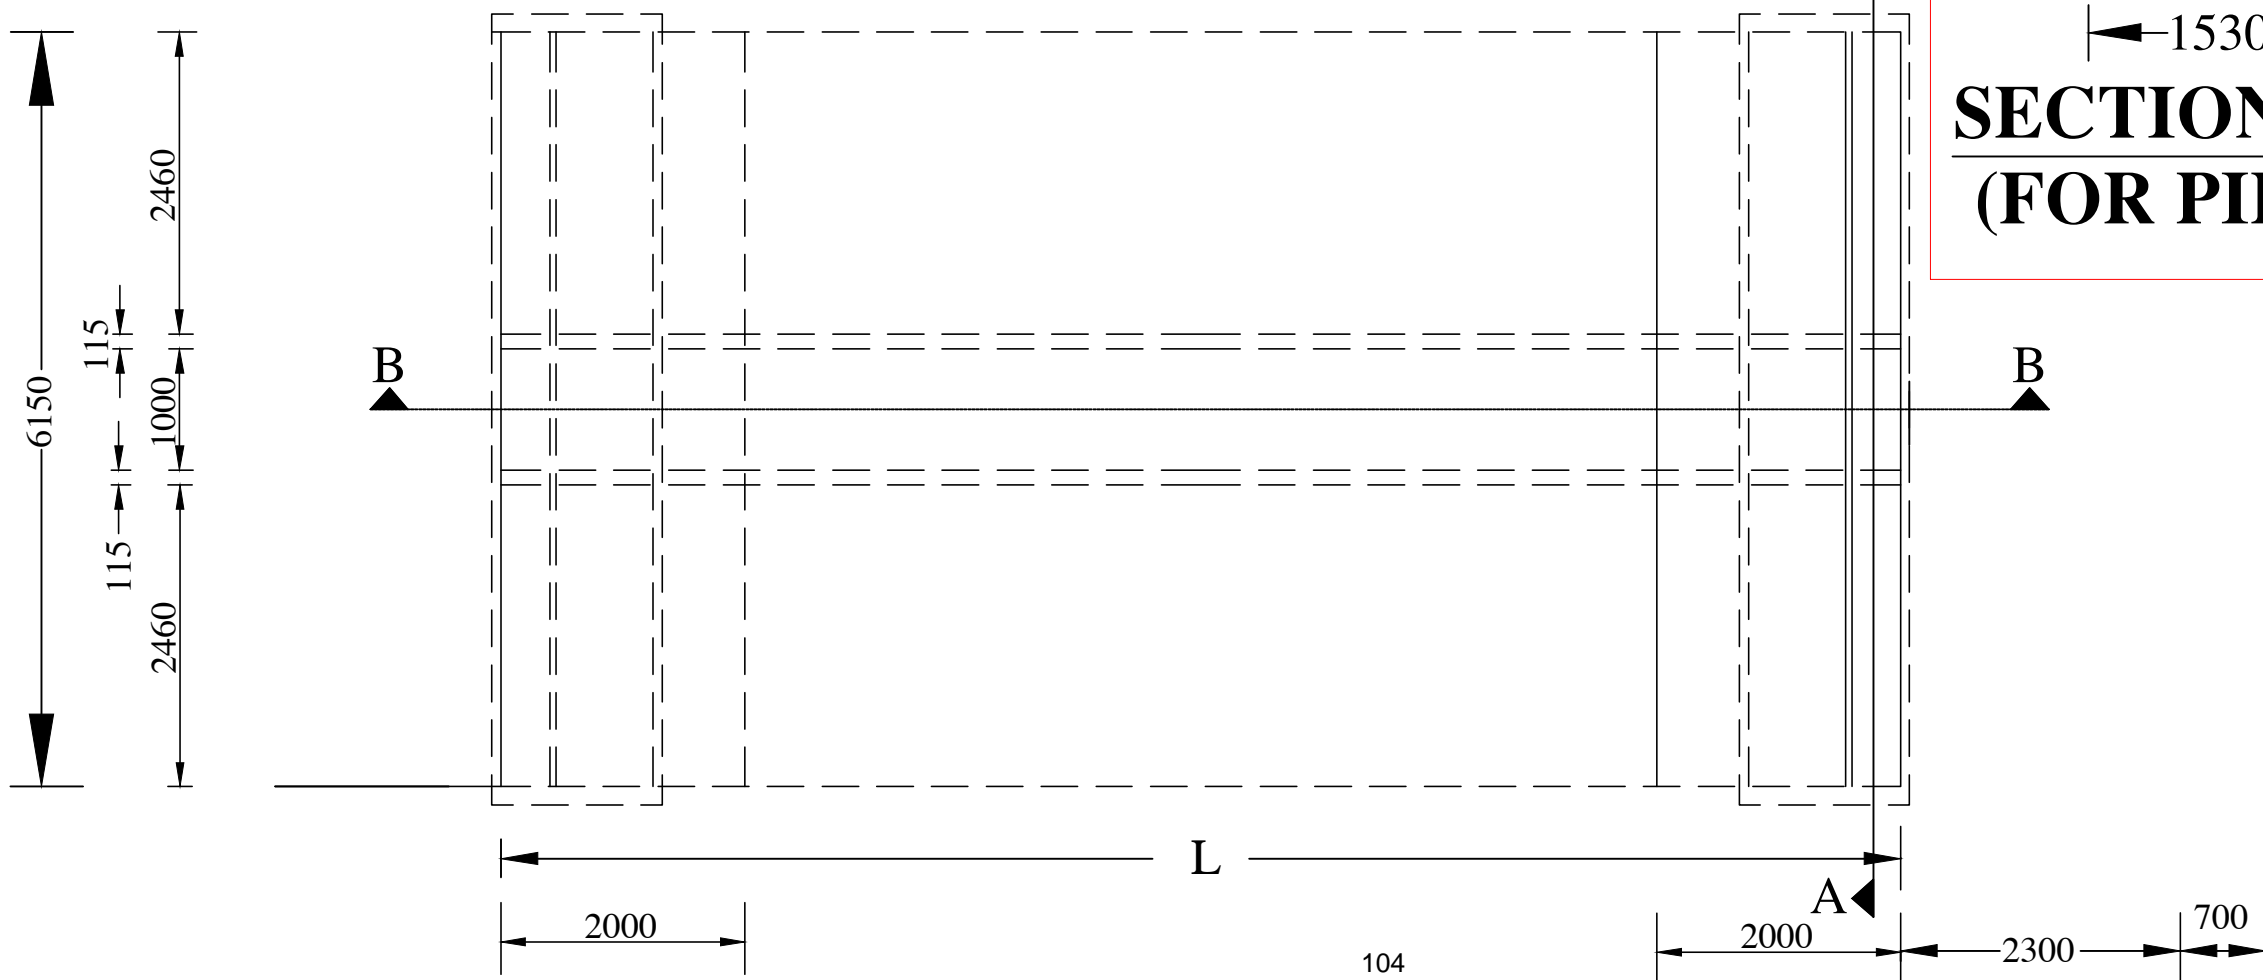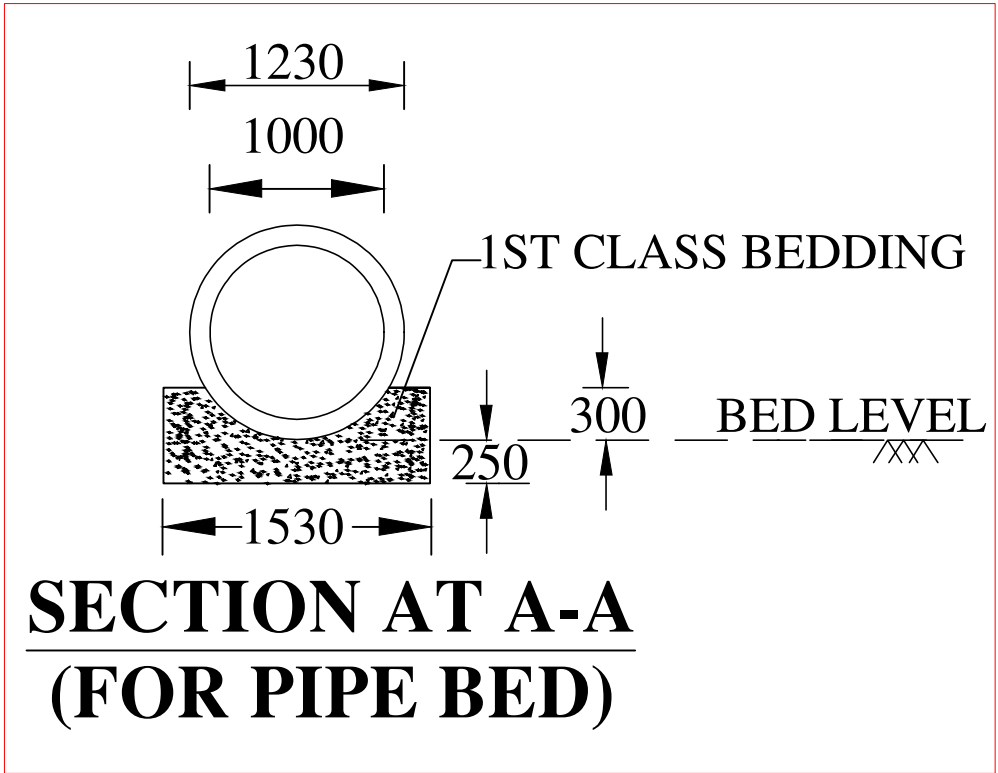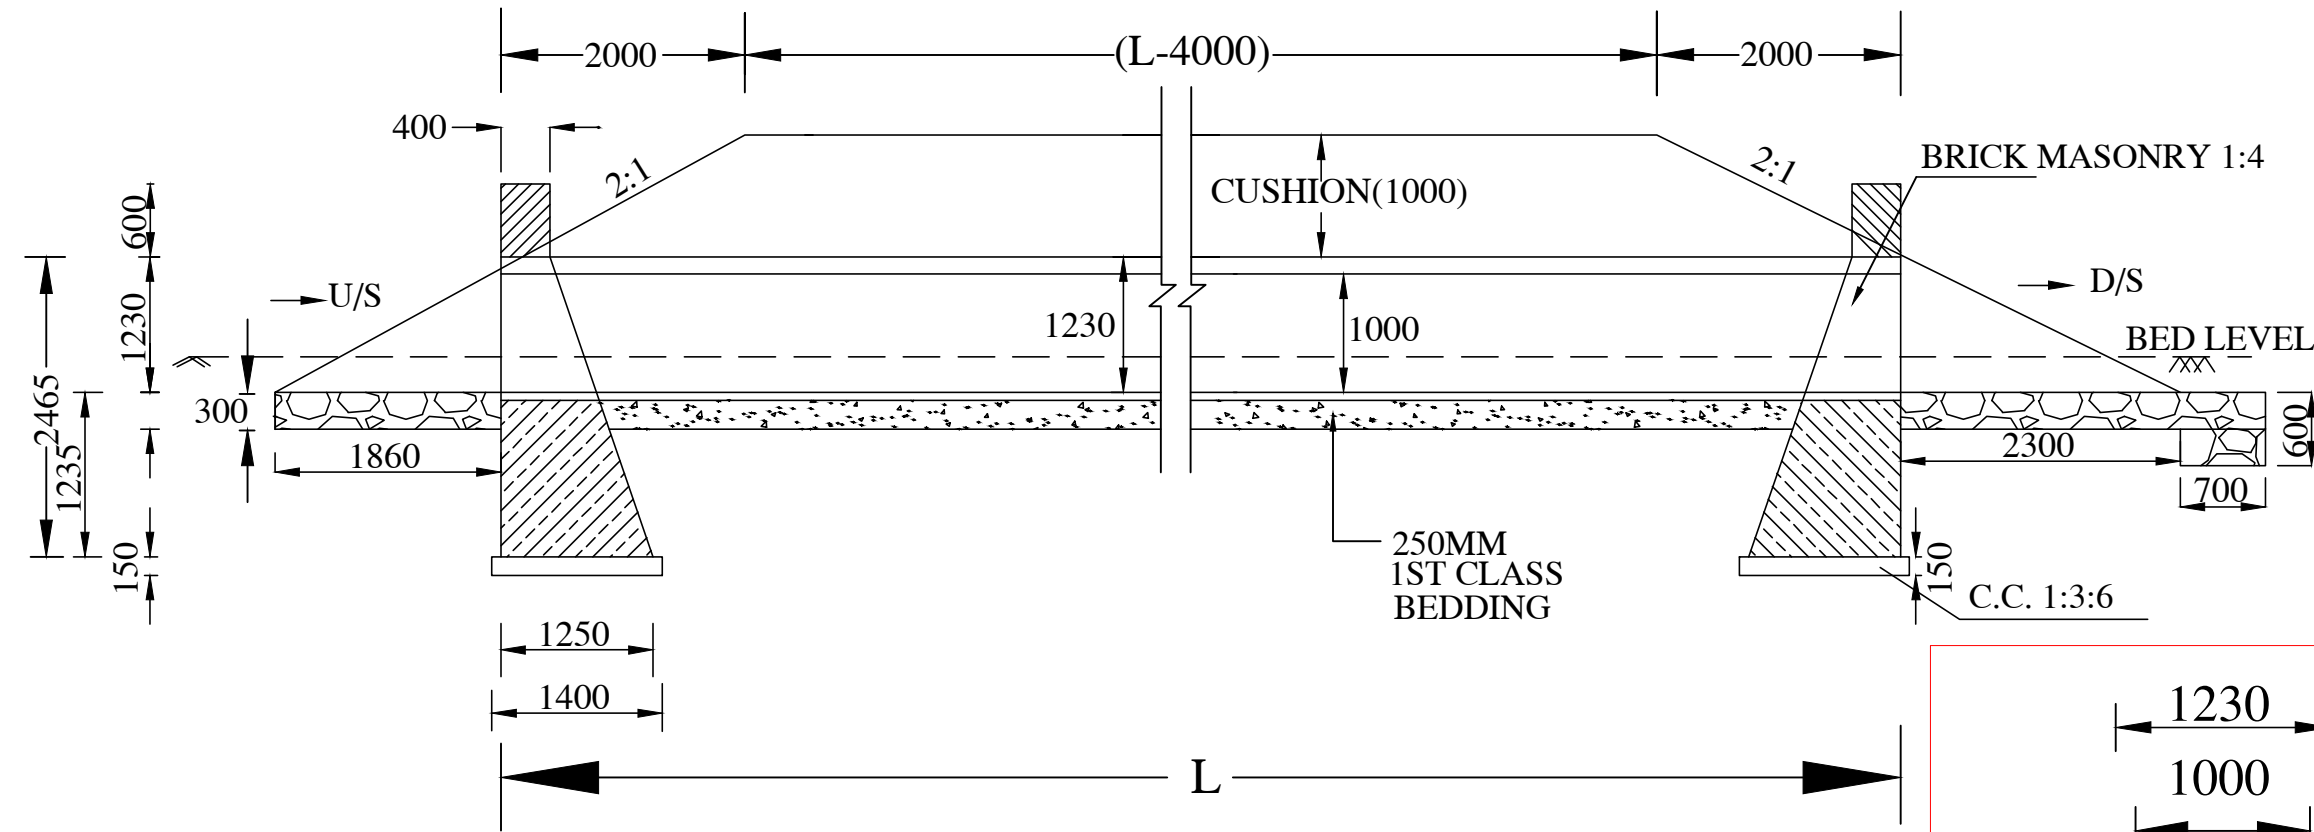

- NOTES:-**
1. ALL DIMENSIONS ARE IN mm UNTIL & UNLESS STATED.
 2. THE PIPES SHALL BE RCC NP.3 THE SPECIFICATIONS OF PIPES SHALL BE AS PER IS:458 OF 1988
 3. MINIMUM CUSHION ABOVE PIPE INCLUDING ROAD CRUST SHALL BE 1.0M

SCALE: NOT TO SCALE

PROJECT TITLE:
Sustainable Wetlands and Integrated Fisheries Transformation (SWIFT) Project

CLIENT :

ARIAS Society
GOVERNMENT OF ASSAM
Assam Rural Infrastructure and Agricultural Services Society

CONSULTANT :


Shubh
Consultants & Technocrats LLP

DWG TITLE :
STANDARD DRAWING
RCC PIPE CULVERT WITH SINGLE PIPE
1 METRE DIA.NP-3
(REF: IRC:SP20)


DATE :

CHECKED BY: **SUBMITTED TO:** **RECOMMENDED BY:** **APPROVED BY:**


DATE :	DATE :	DATE :	DATE :
TEAM LEAD	A.E.	E.E.	S.E.

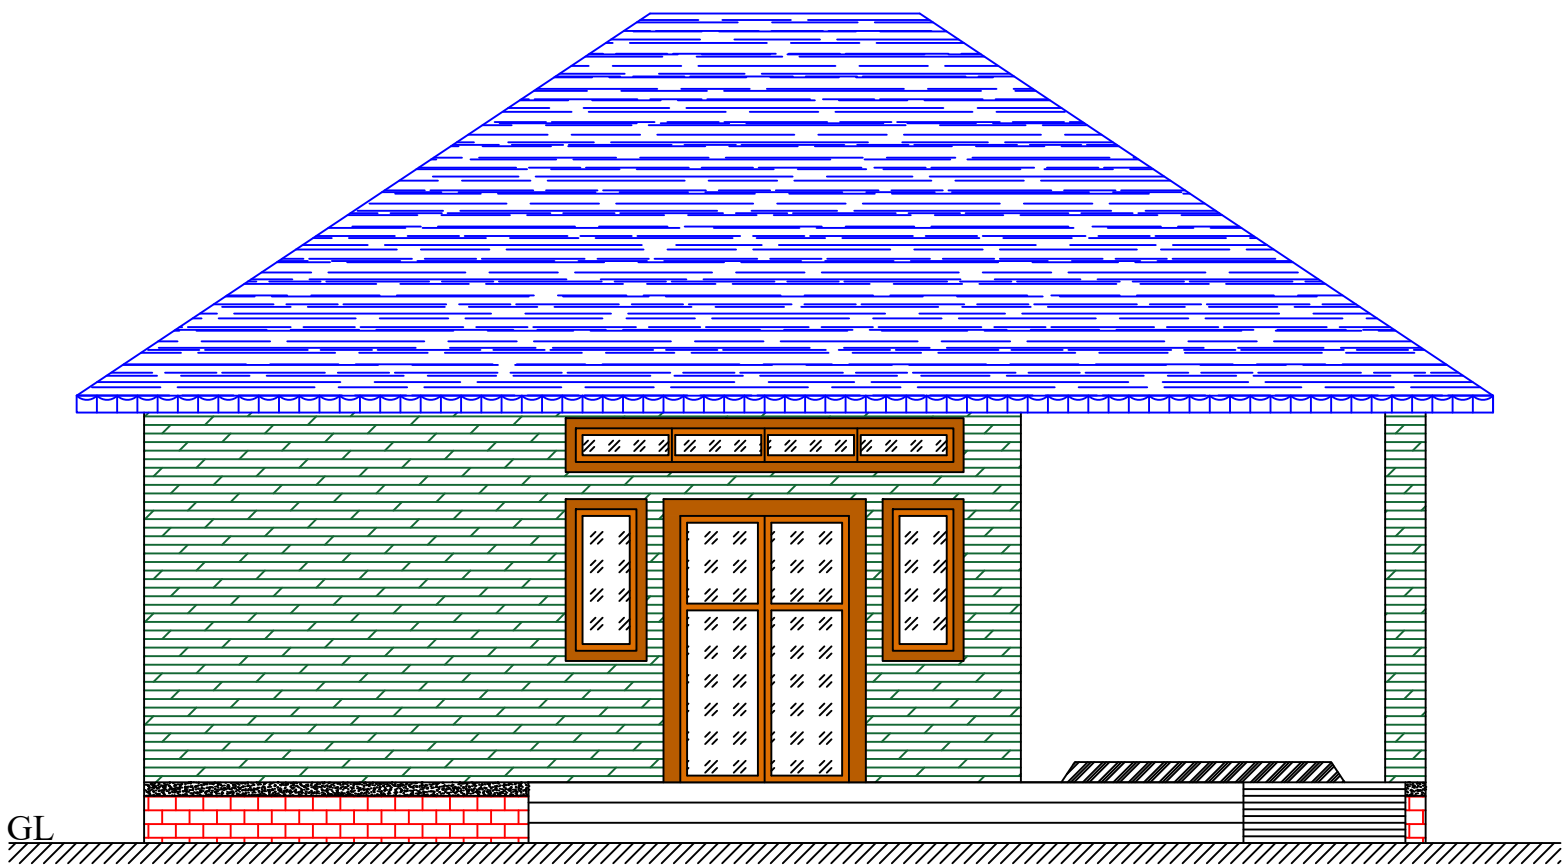




FRONT ELEVATION

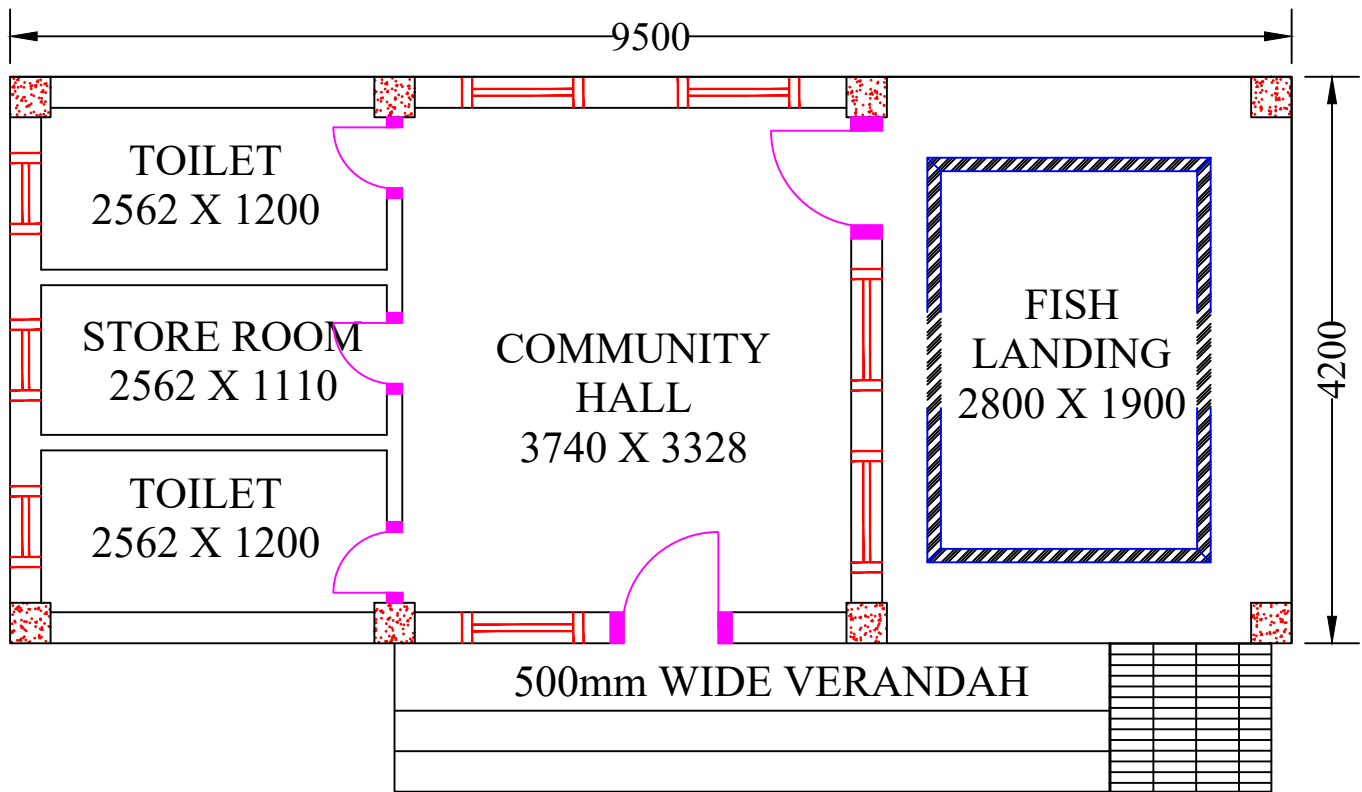



PLAN

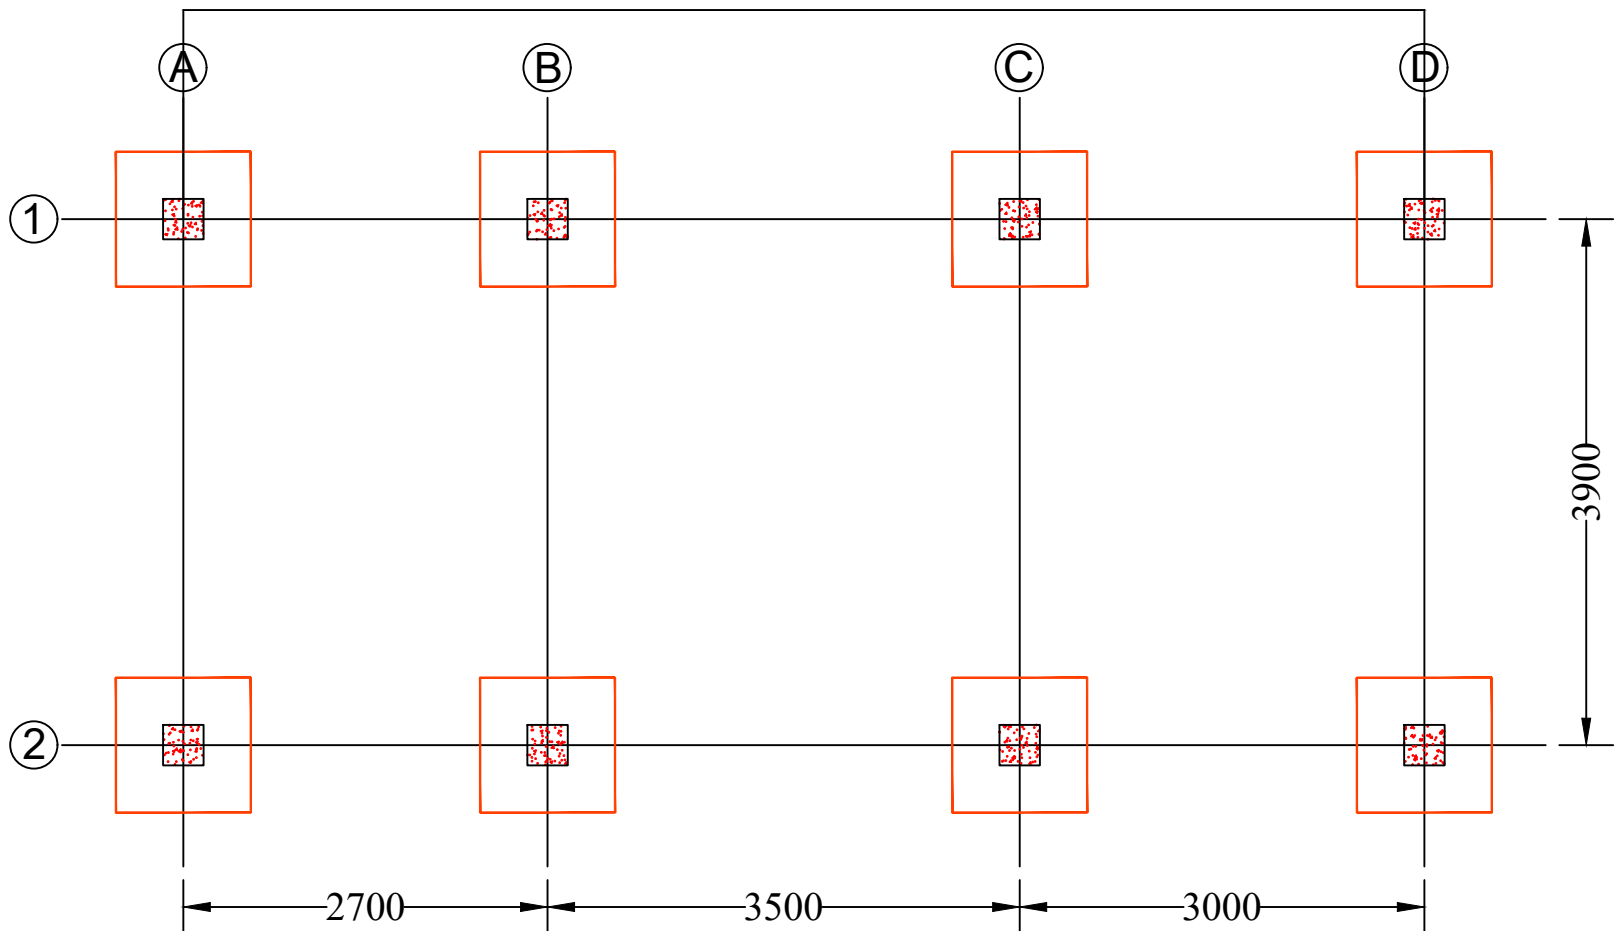

FOOTING LAYOUT

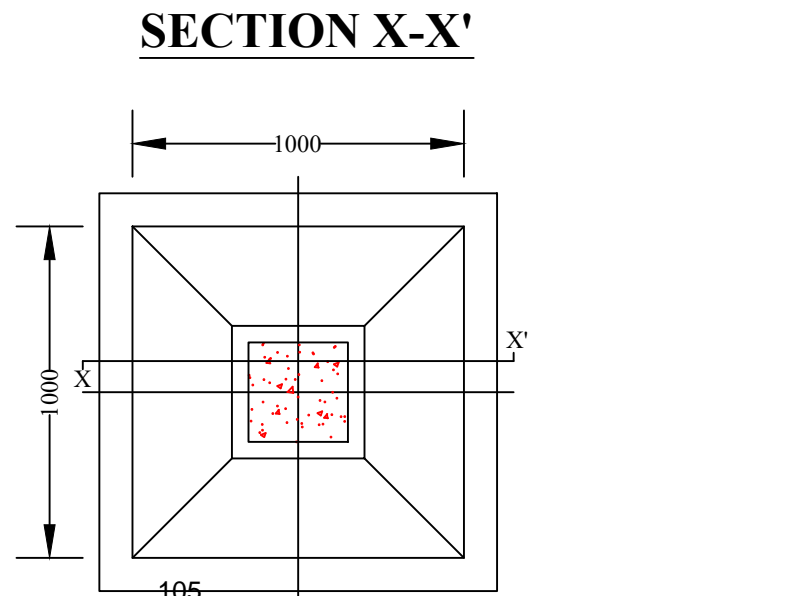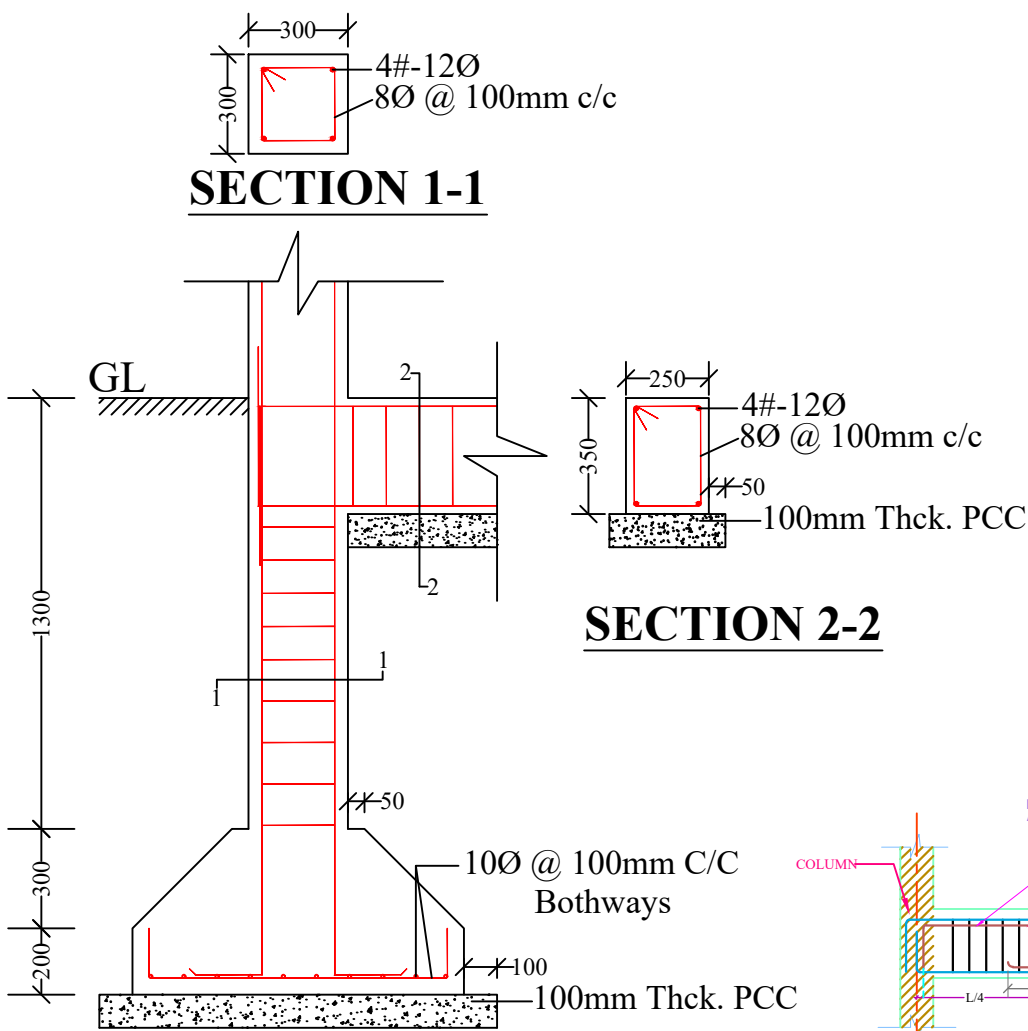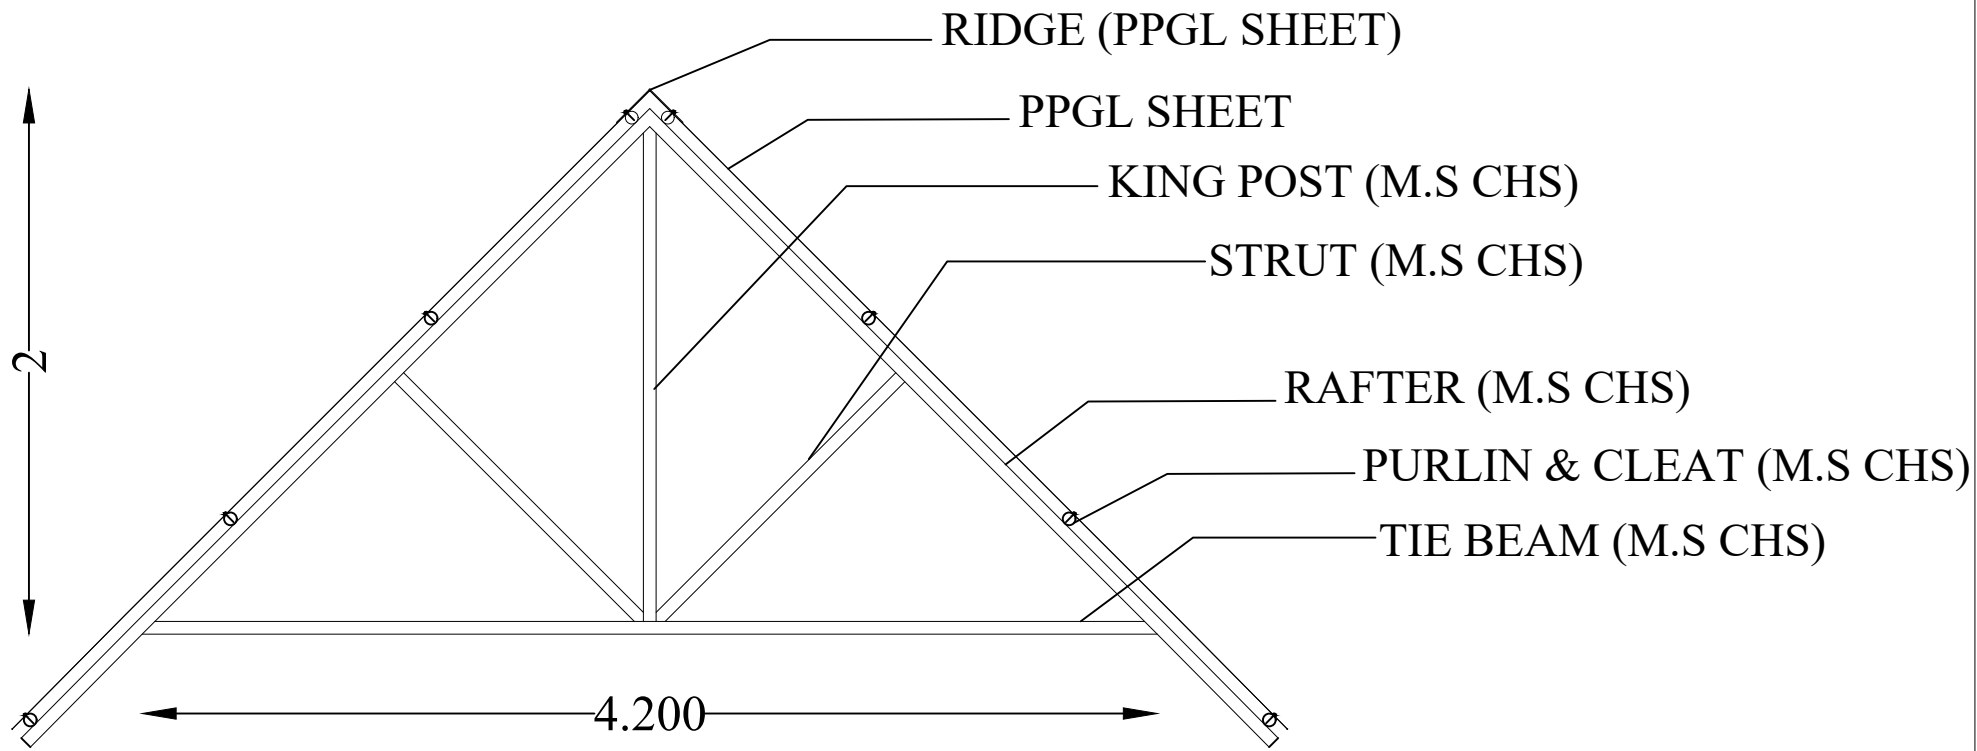

FOOTING PLAN

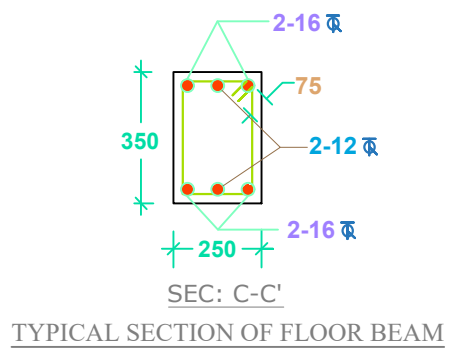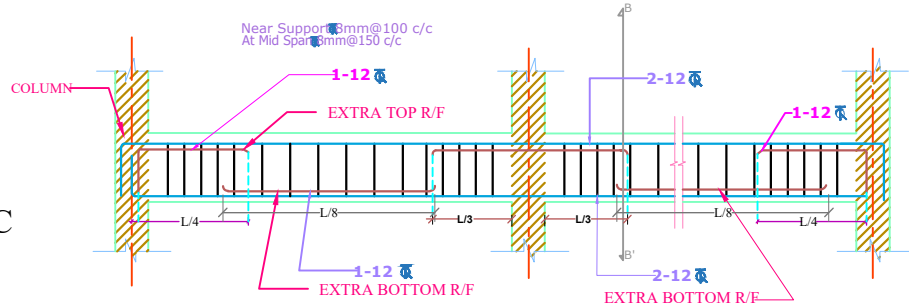



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

- All dimensions are in millimetres.
- All dimensions are to be read and not to be scaled.
- Grade of Concrete used : M-20.
- Grade of Steel Reinf. used : TMT (Grade-500)
- Clear cover for reinf. bars :
 - In Foundations - 50 mm.
 - In Columns - 40 mm.
 - In Beams - 25 mm.
 - In Slabs - 20 mm.
- Not more than one third of the total number of main bars shall be over-lapped at any section of a column.
- Laps, anchorage of reinf. bars shall be as per I.S.456-2000.
- Maximum size of Coarse Aggregate shall be 20 mm and down graded.
- Aggregate shall comply with the requirements of I.S.:383-1970.
- Lap / Development length = 50 x 'd' where, 'd' = diameter of reinforcing bar.
- In addition to Lintels, R.C.C. band at sill level should also be provided.
- Use R.C.C. bands also in all vertical sides of openings.
- Protruding rods to be provided in columns for embedding all brick walls.
- Joints between walls & beams may be embedded with epoxy based joint filling compounds.
- All Reinforcement detailing should meet all the general requirements of IS:4326 and IS:13920.
- Dimensions shall be in conjunction with Architectural drawings. Architectural drawings shall be followed in the event of any discrepancy with due regard to the Structural requirements. Any major deviations shall be brought to the notice of the Engineer-in-charge.

SCALE: NOT TO SCALE

PROJECT TITLE: Sustainable Wetlands and Integrated Fisheries Transformation (SWIFT) Project			
CLIENT : ARIAS SOCIETY			
CONSULTANT : SHUBH CONSULTANTS AND TECHNOCRATS LLP			
DWG TITLE : STANDARD DRAWING PLAN & CROSS-SECTION OF FISH LANDING SHED CUM COMMUNITY CENTRE			
DATE :			
CHECKED BY:	SUBMITTED TO:	RECOMMENDED BY:	APPROVED BY:
DATE :	DATE :	DATE :	DATE :
TEAM LEAD	A.E.	E.E.	S.E.

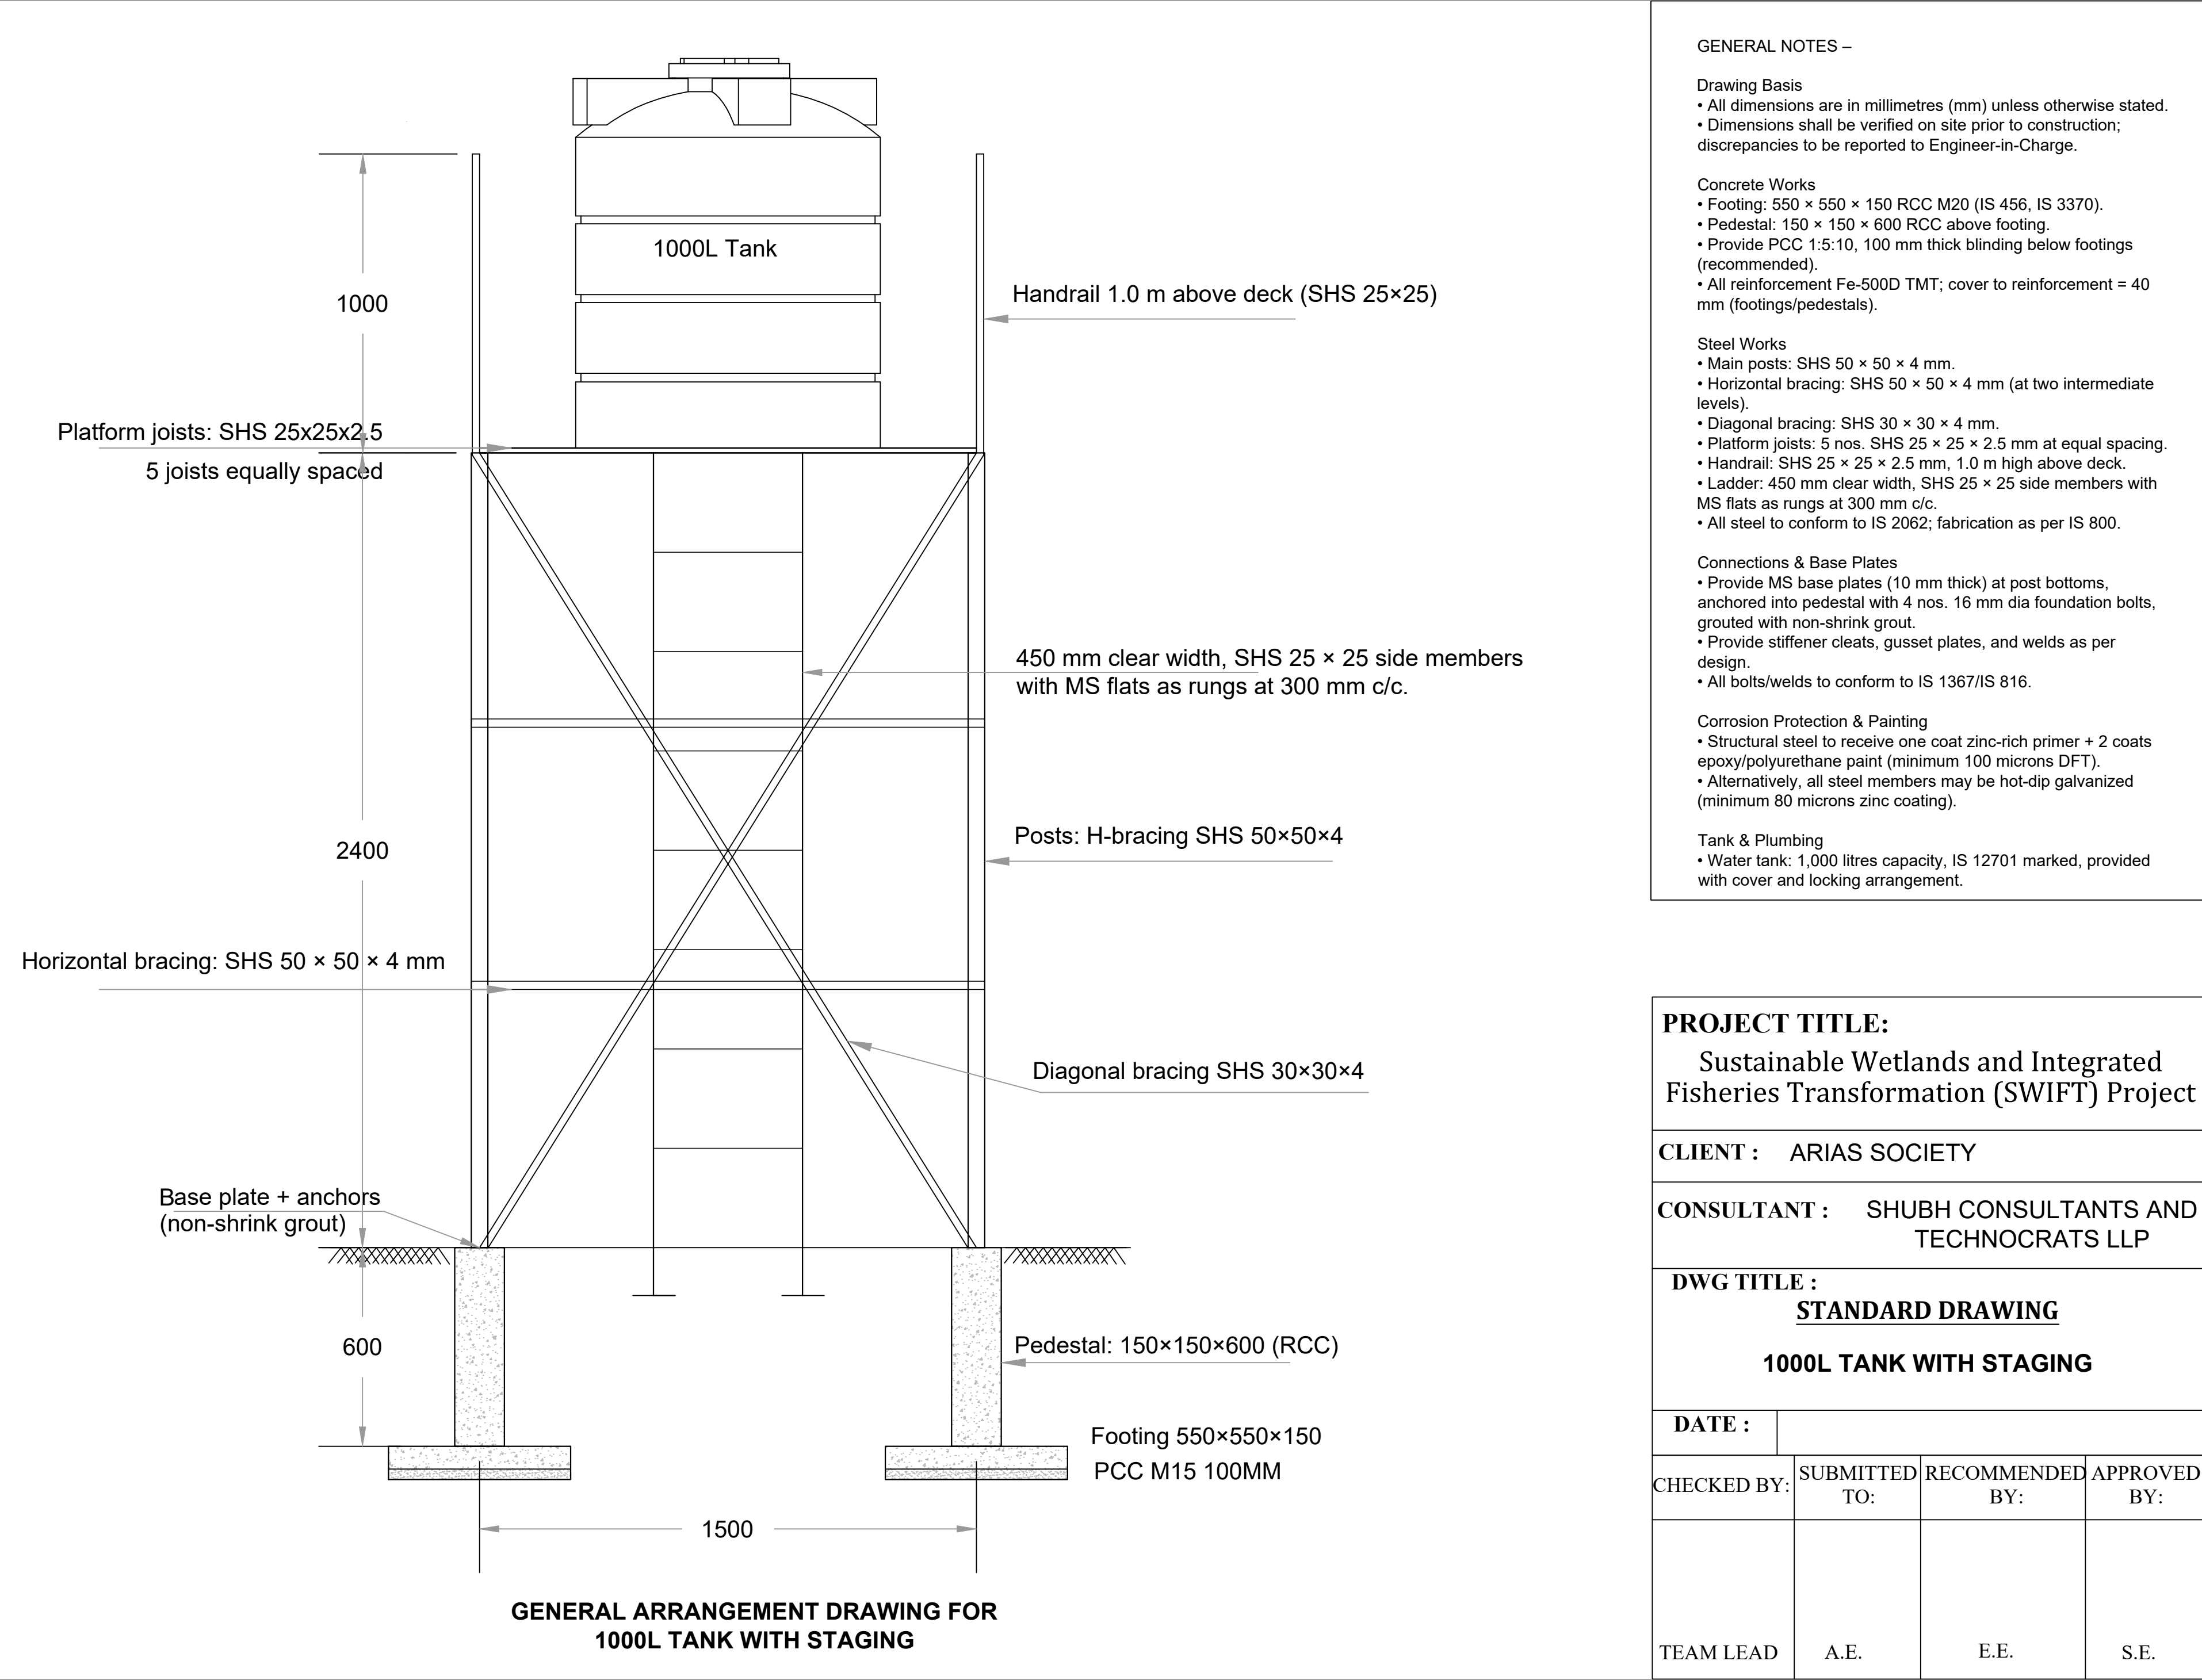

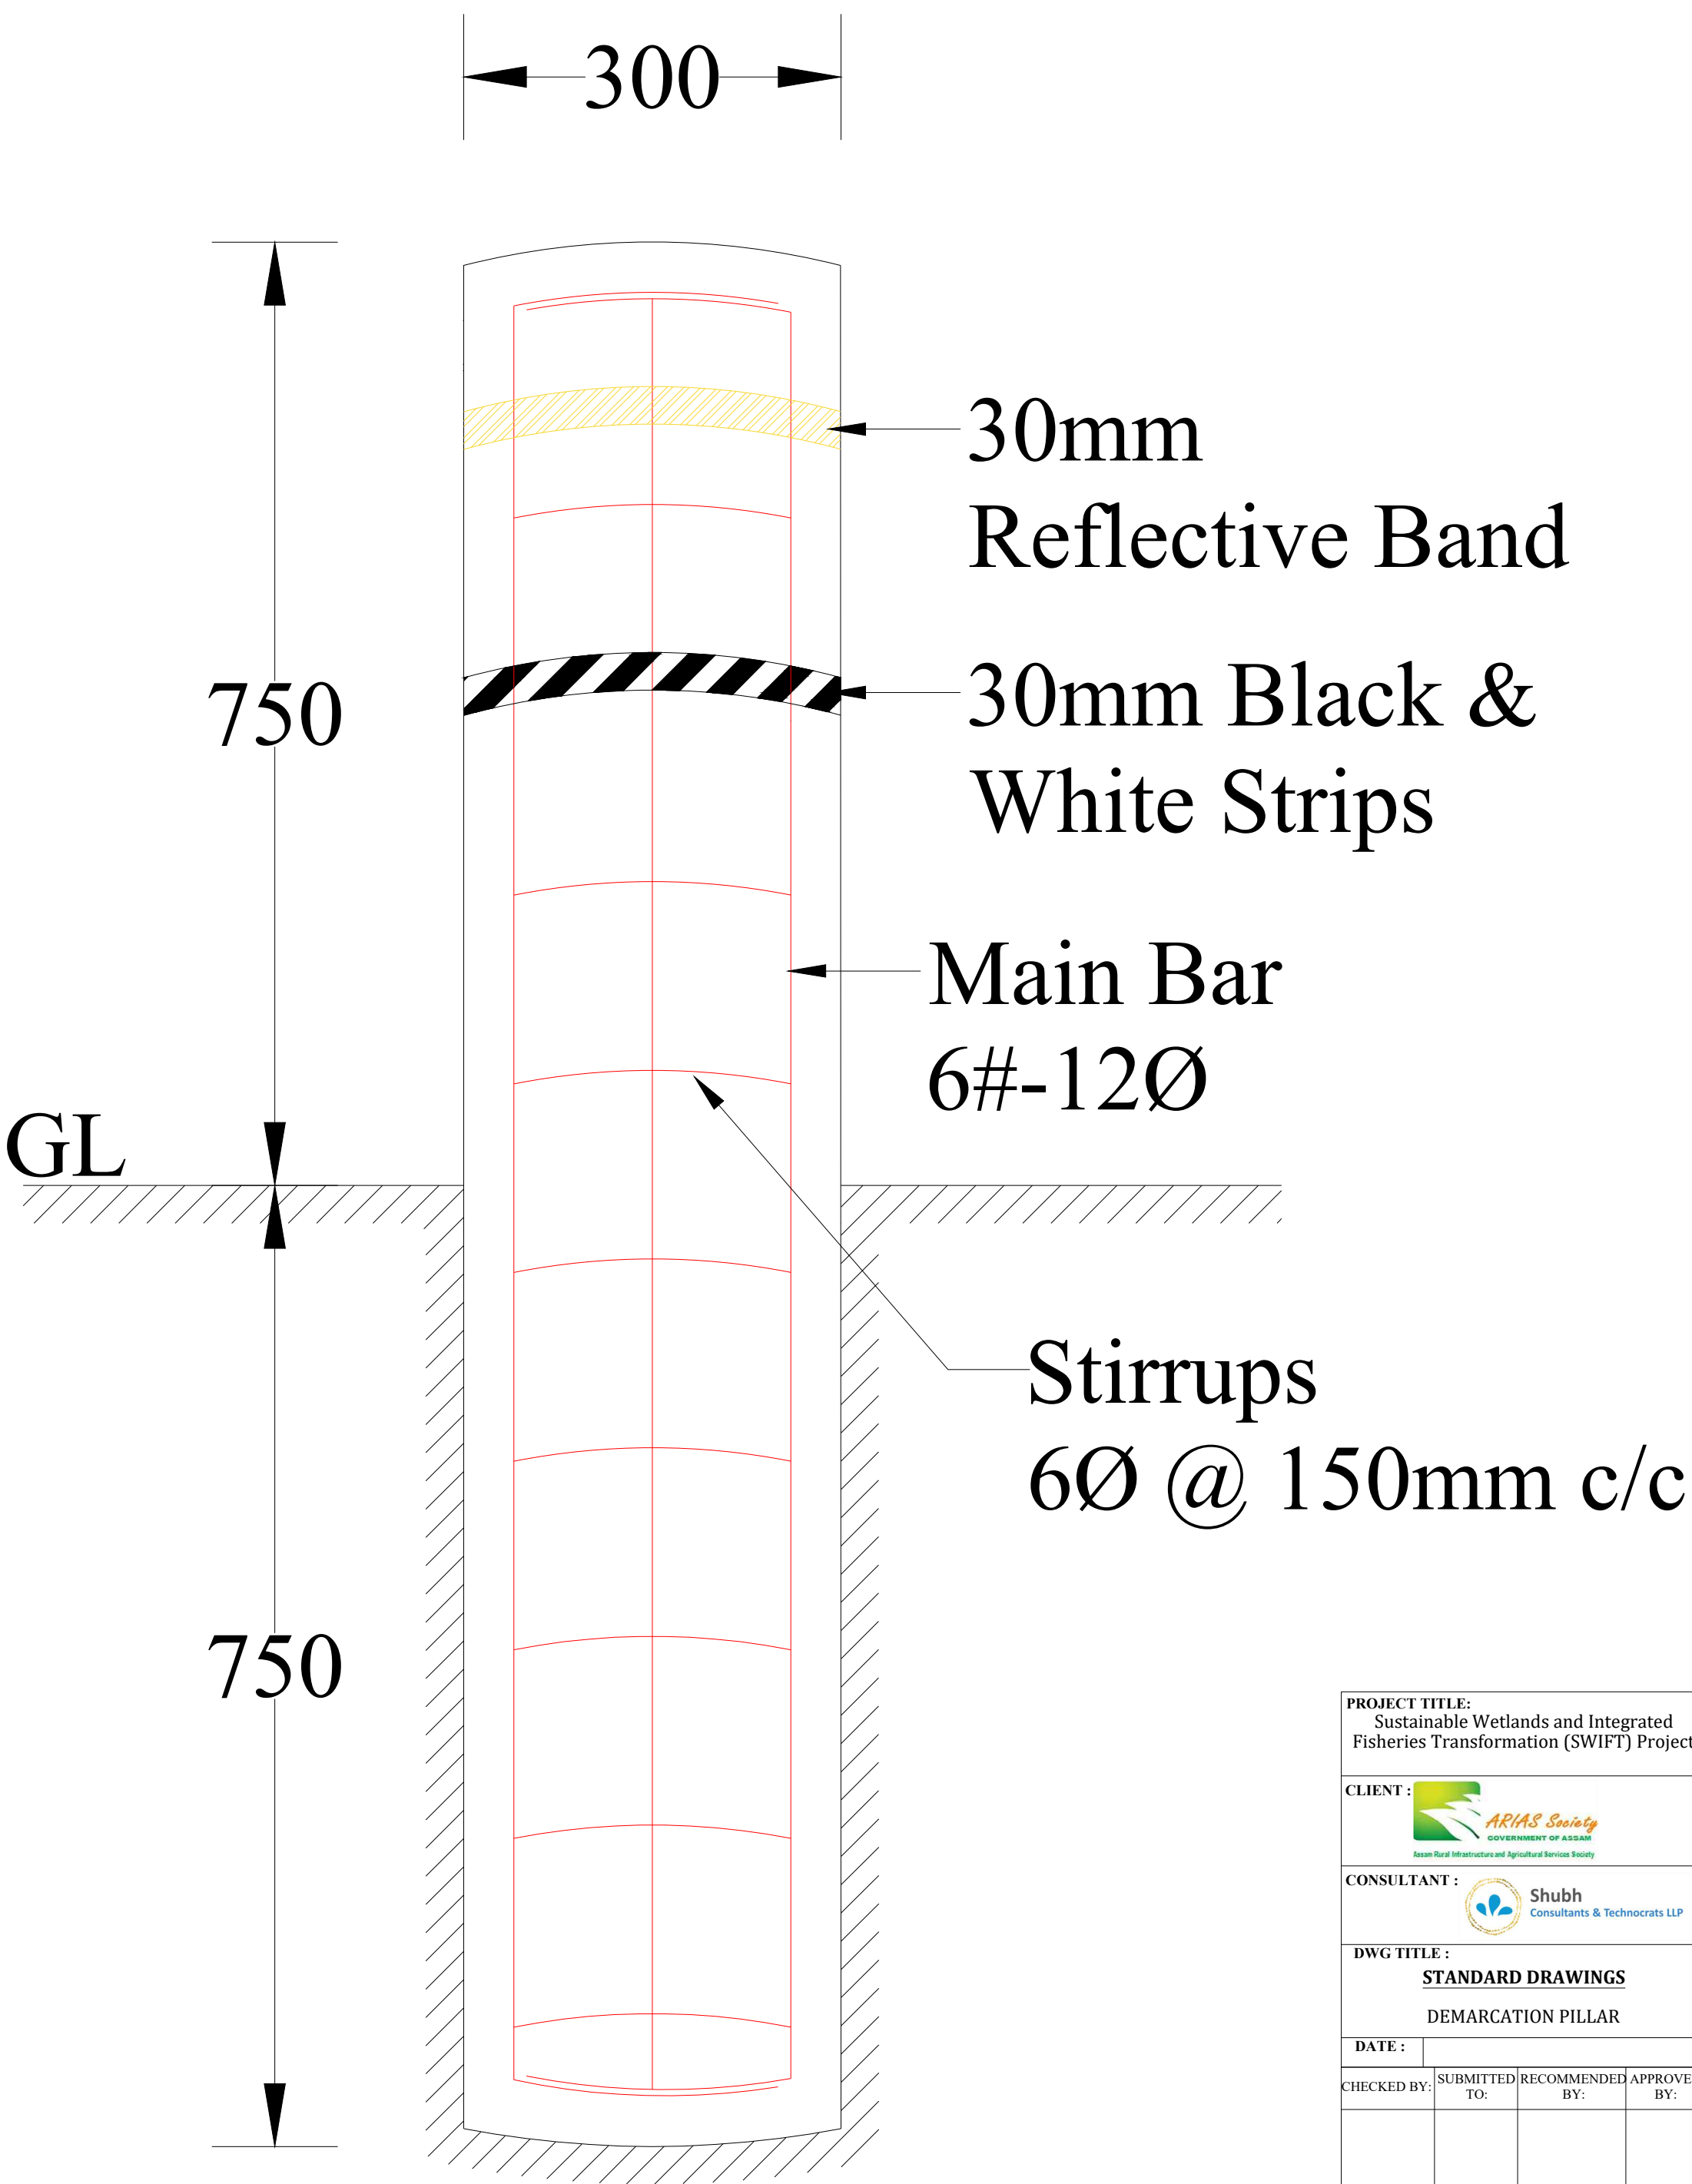

PROJECT TITLE: Sustainable Wetlands and Integrated Fisheries Transformation (SWIFT) Project			
CLIENT :  Assam Rural Infrastructure and Agricultural Services Society			
CONSULTANT :  Shubh Consultants & Technocrats LLP			
DWG TITLE : STANDARD DRAWINGS DEMARCATION PILLAR			
DATE :			
CHECKED BY:	SUBMITTED TO:	RECOMMENDED BY:	APPROVED BY:
DATE :	DATE :	DATE :	DATE :
TEAM LEAD	A.E.	E.E.	S.E.

TYPICAL SECTION OF APPROACH ROAD


GSB of thickness 200 mm
Well-Compacted Natural Soil

Edge-Restraint Wall

Road Width- 3.0m

Slope 2%

Slope 2%

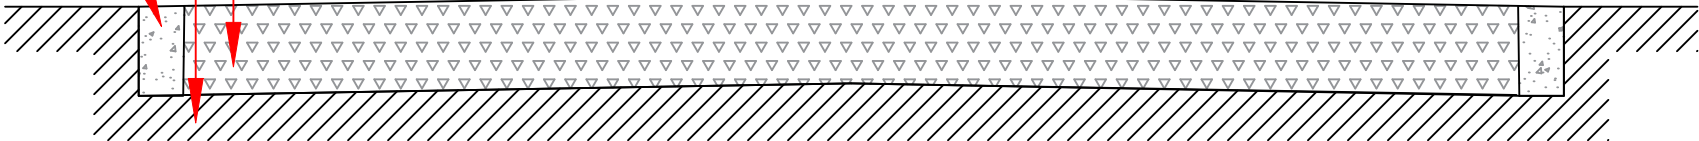


PROJECT TITLE:
Sustainable Wetlands and Integrated
Fisheries Transformation (SWIFT) Project




DWG TITLE :
TYPICAL SECTION OF
APPROACH ROAD


DATE :			
CHECKED BY:	SUBMITTED TO:	RECOMMENDED BY:	APPROVED BY:
DATE :	DATE :	DATE :	DATE :
TEAM LEAD	A.E.	E.E.	S.E.

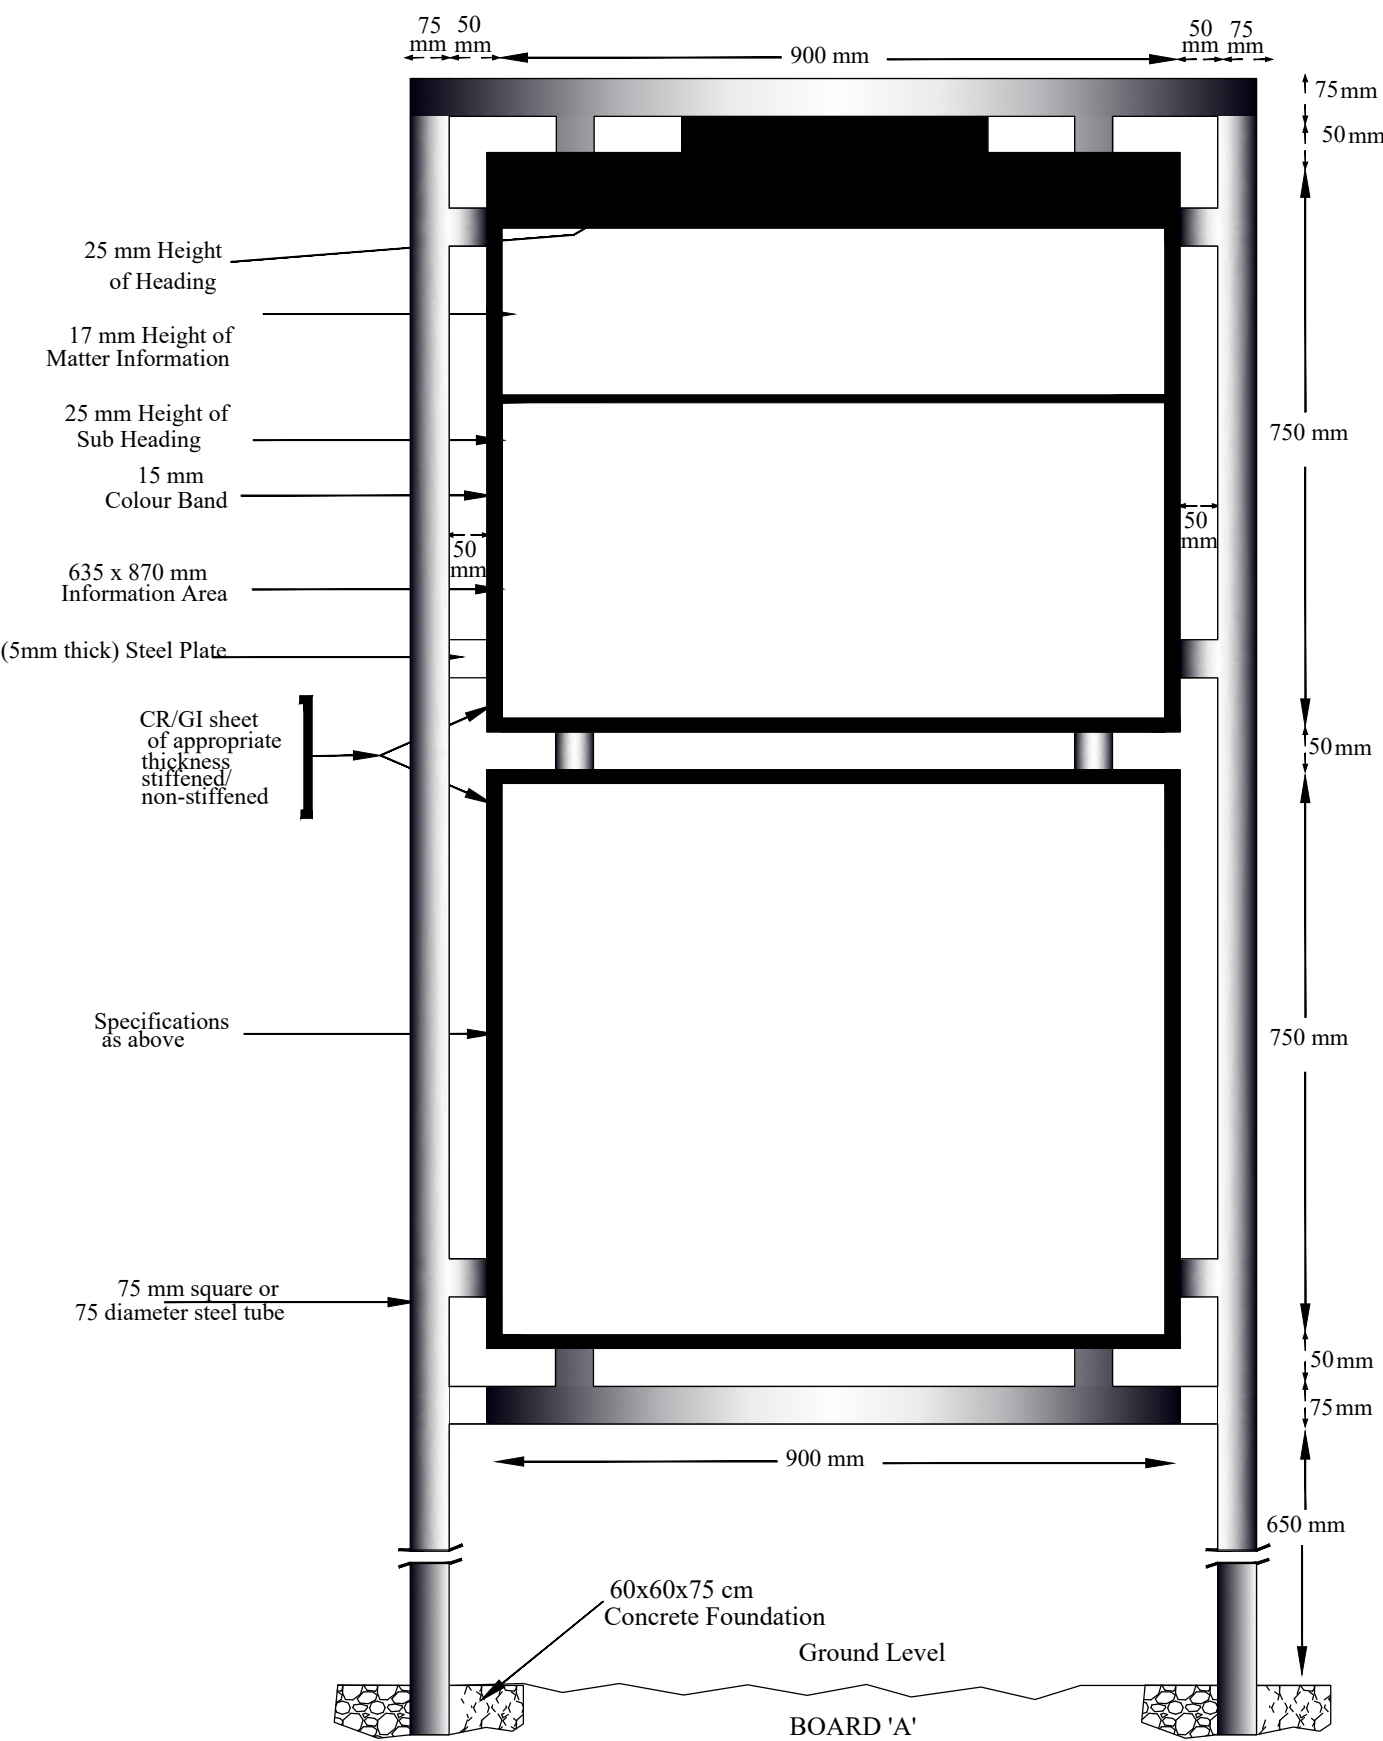


PROJECT TITLE: Sustainable Wetlands and Integrated Fisheries Transformation (SWIFT) Project			
CLIENT : ARIAS SOCIETY			
CONSULTANT : SHUBH CONSULTANTS AND TECHNOCRATS LLP			
DWG TITLE : STANDARD DRAWING INFORMATION BOARD			
DATE :			
CHECKED BY:	SUBMITTED TO:	RECOMMENDED BY:	APPROVED BY:
TEAM LEAD	A.E.	E.E.	S.E.

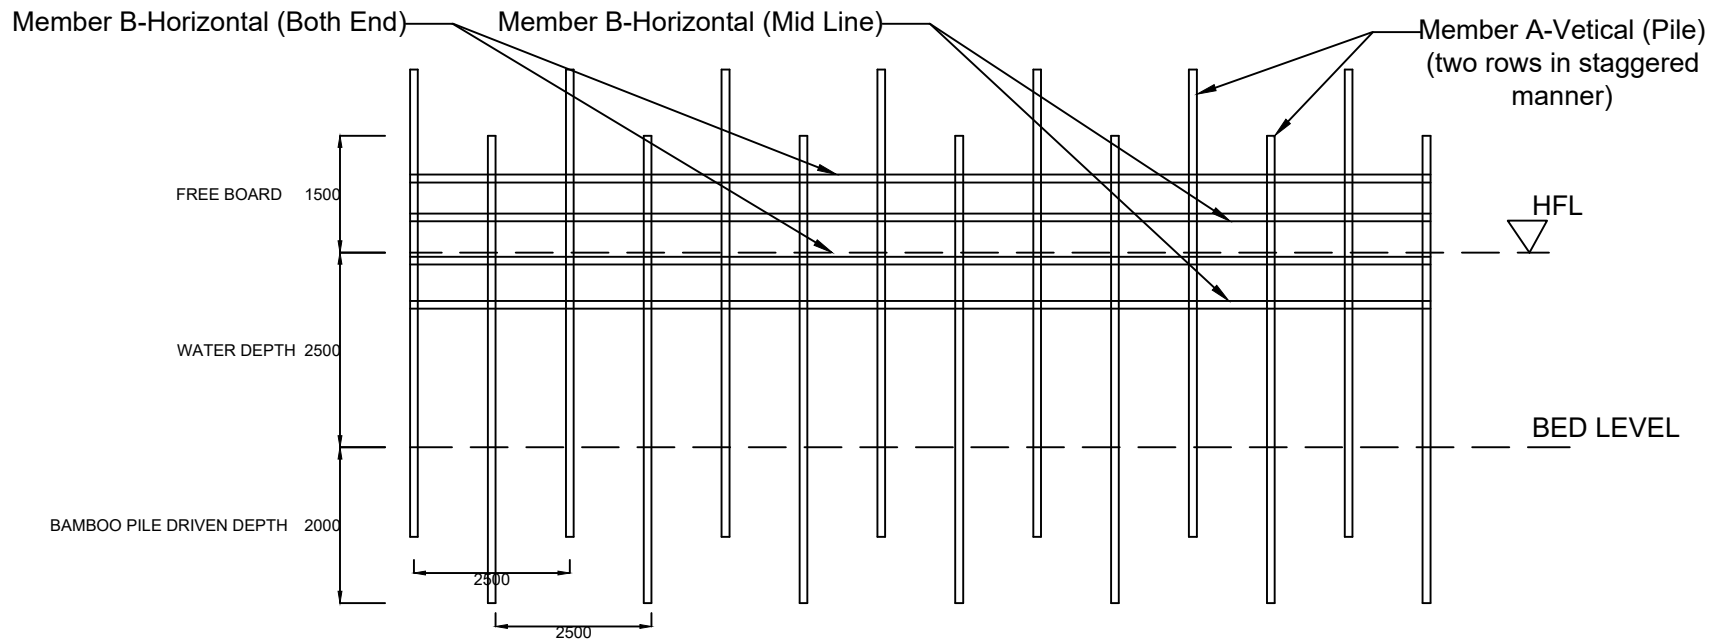


BAMBOO PARTITION/SCREENING STRUCTURE AT BEEL/WETLAND FISHERIES. (FRONT-ELEVATION)

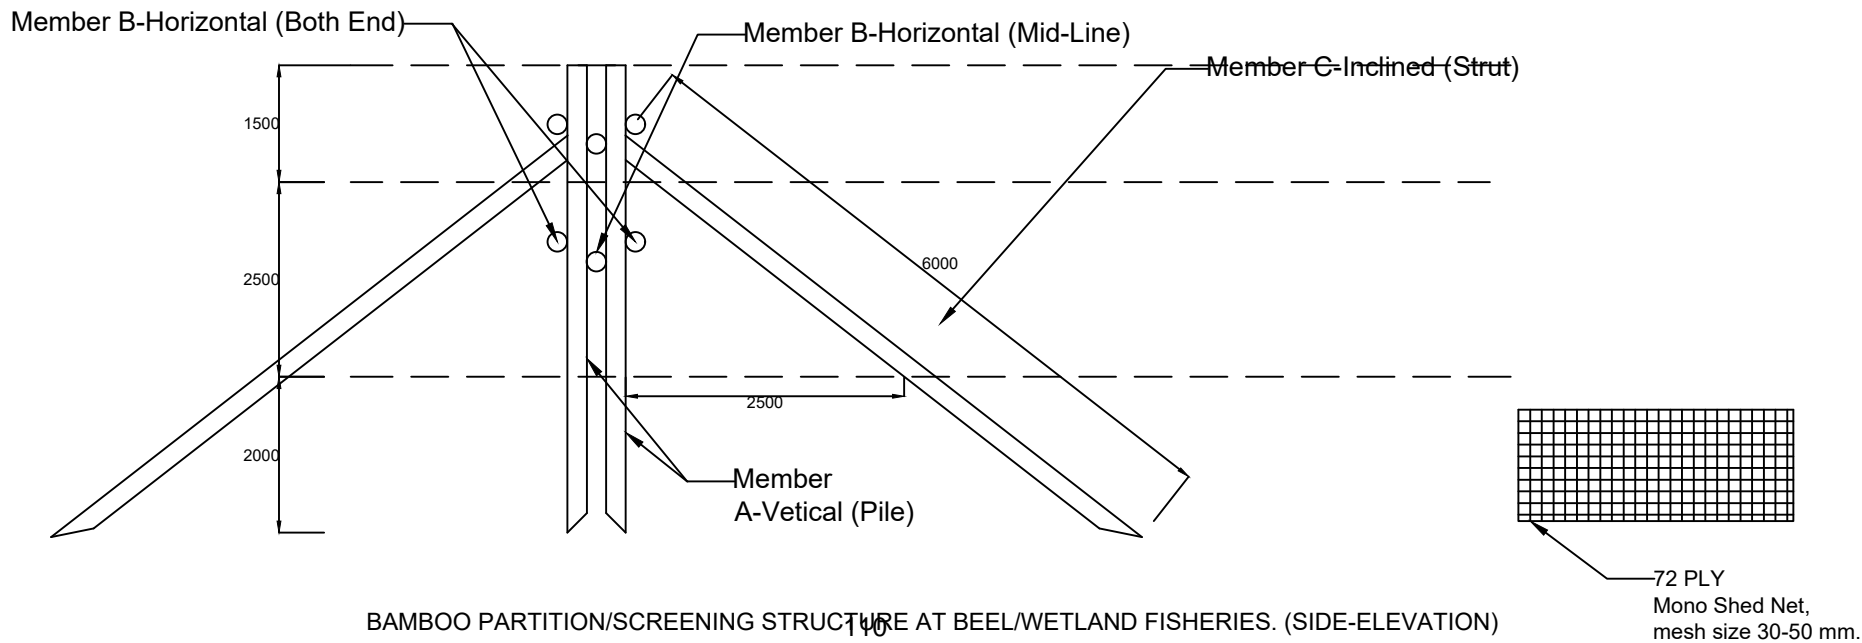


BAMBOO PARTITION/SCREENING STRUCTURE AT BEEL/WETLAND FISHERIES. (SIDE-ELEVATION)

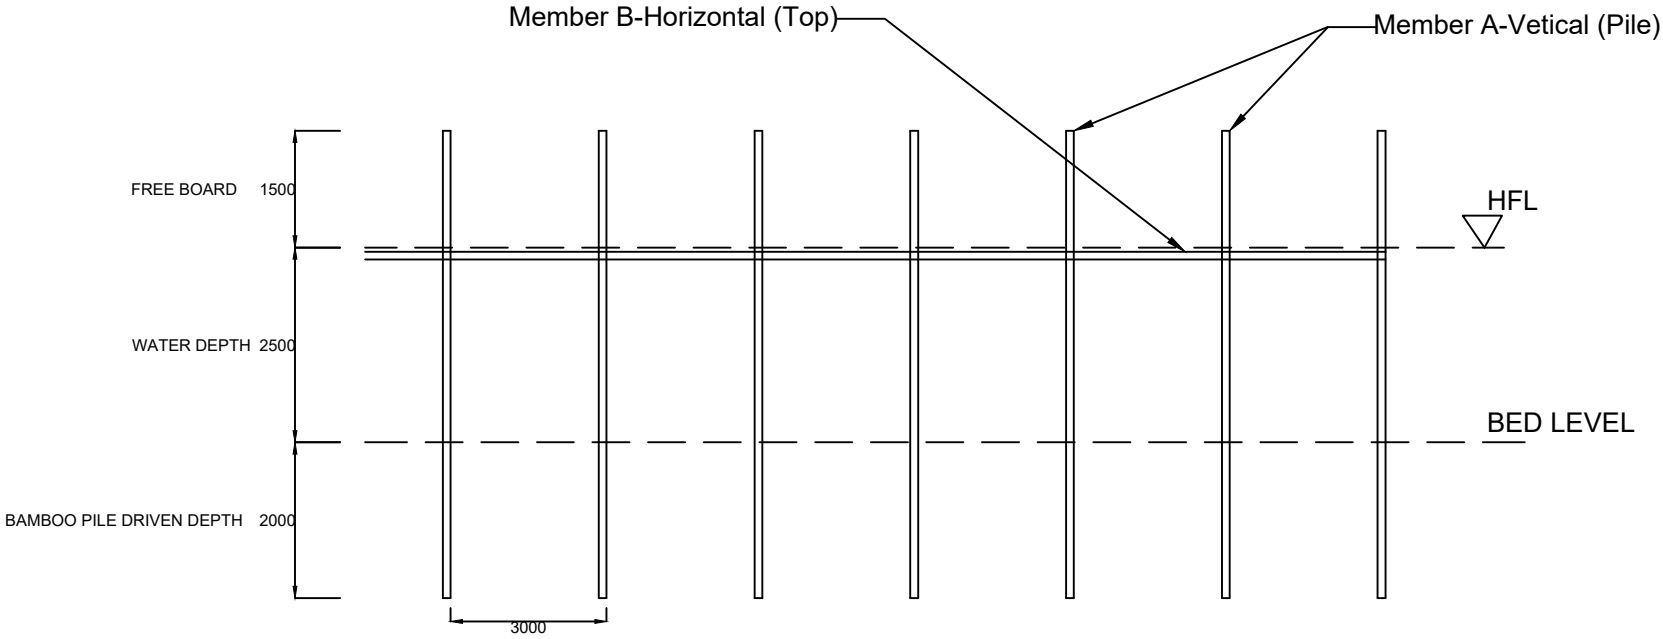


KATAL/CATTLE FISHING STRUCTURE AT BEEL/WETLAND FISHERIES. (FRONT-ELEVATION)

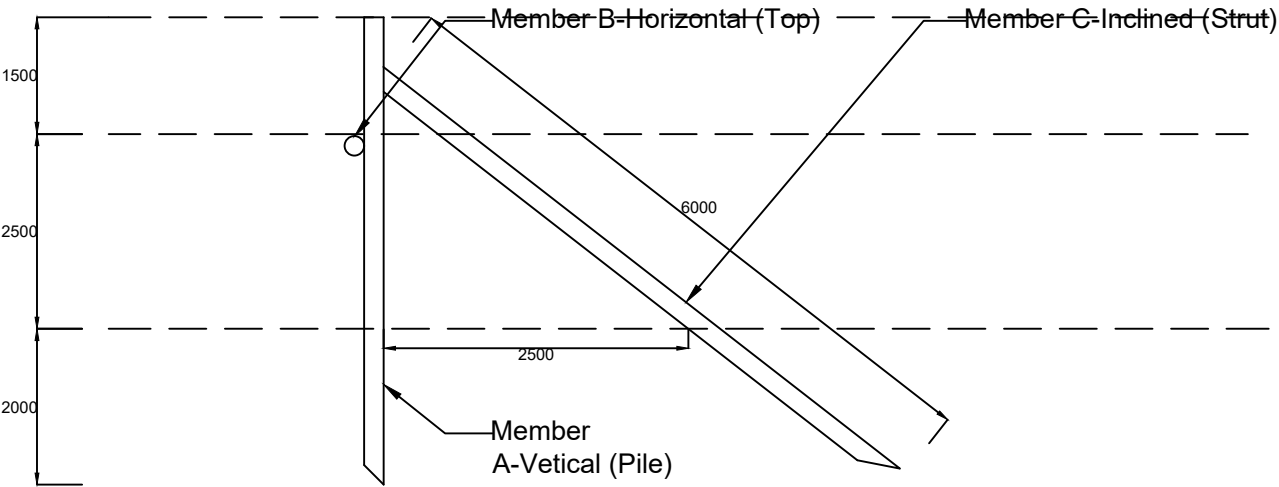

KATAL/CATTLE FISHING STRUCTURE AT BEEL/WETLAND FISHERIES. (SIDE-ELEVATION)

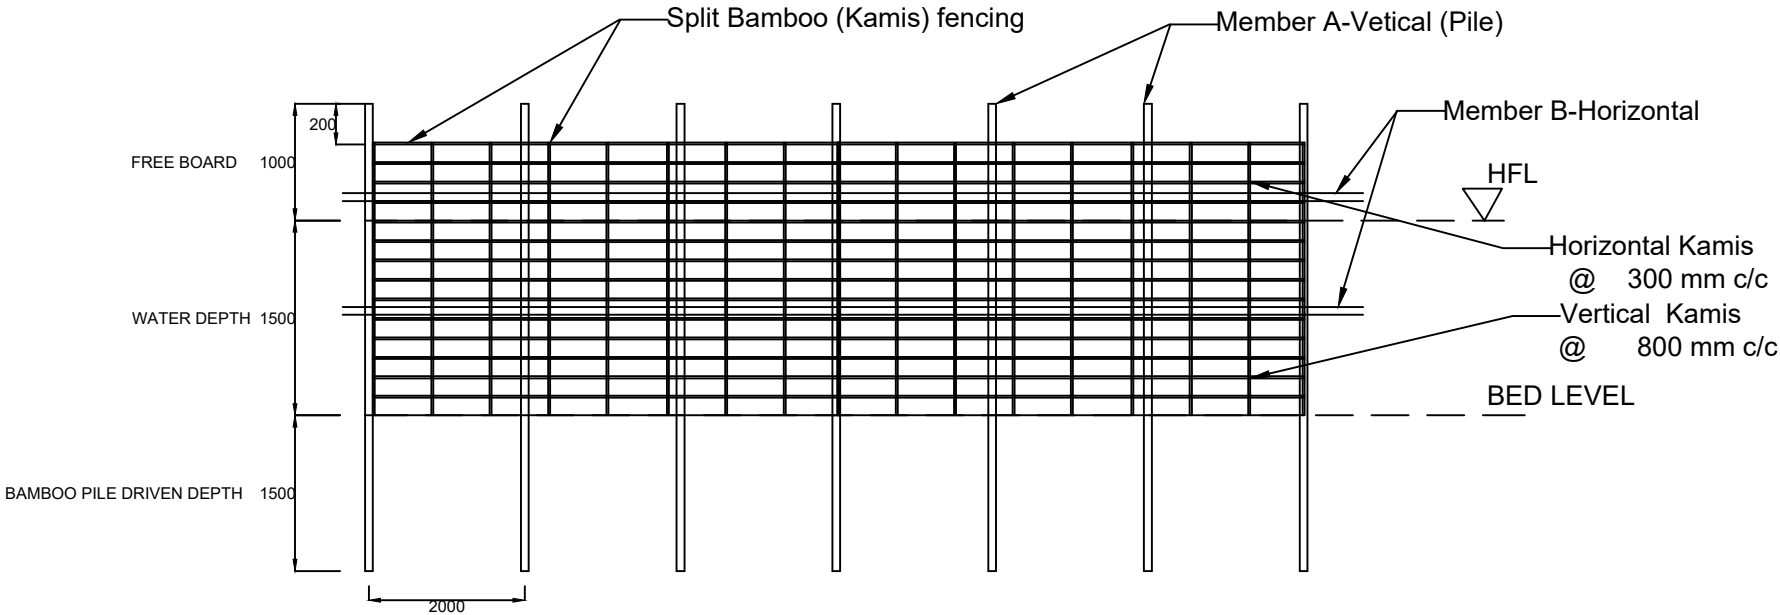

PEN CULTURE STRUCTURE AT BEEL/WETLAND FISHERIES. (FRONT-ELEVATION)

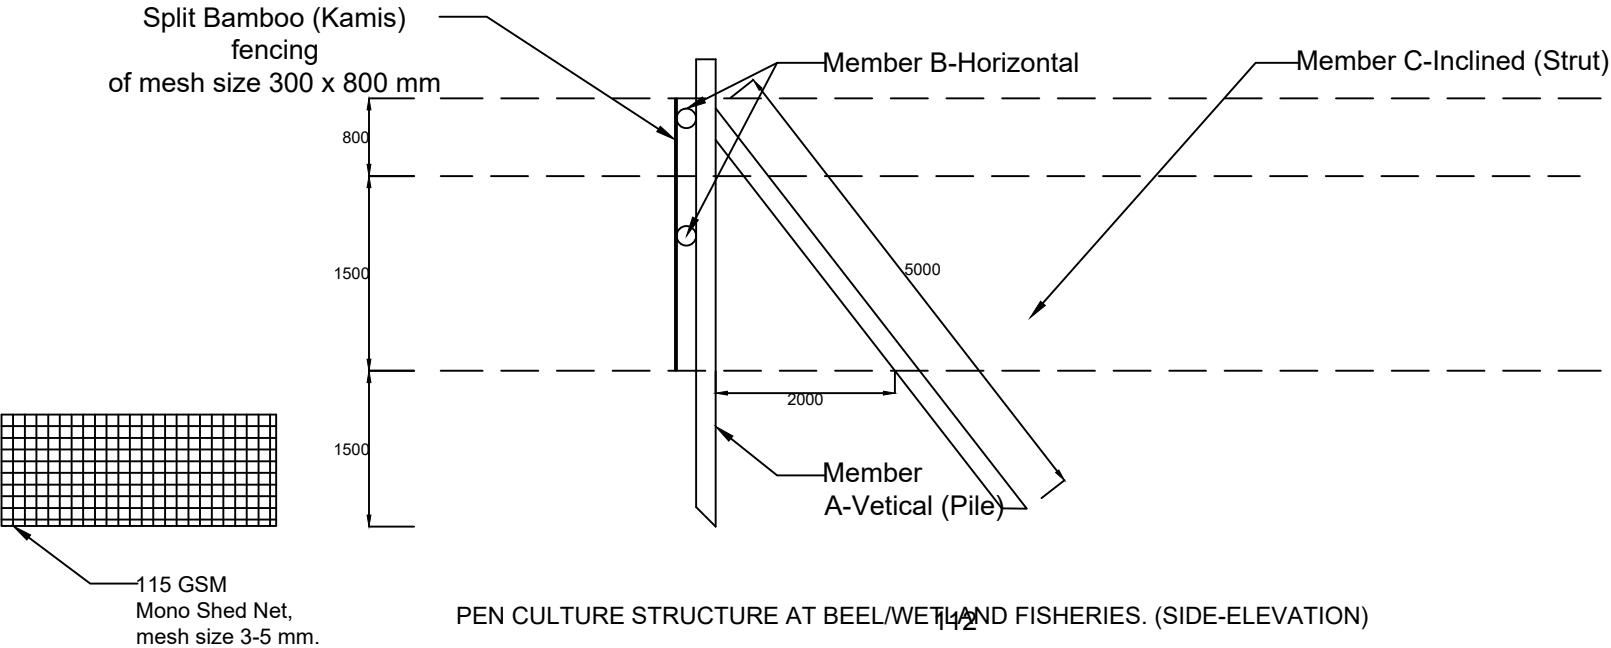

PEN CULTURE STRUCTURE AT BEEL/WETLAND FISHERIES. (SIDE-ELEVATION)